

GENERAL NOTES

1. ALL ENTRANCES SHALL CONFORM TO THE DELAWARE DEPARTMENT OF TRANSPORTATION'S (DELDOT'S) CURRENT STANDARDS AND REGULATIONS FOR SUBDIVISION STREETS AND STATE HIGHWAY ACCESS AND SHALL BE SUBJECT TO ITS APPROVAL

2. ALL MATERIALS AND WORKMANSHIP, INCLUDING STORM DRAIN PIPING, INLET, MANHOLE AND END SECTION INSTALLATION, WITHIN THE STATE OF DELAWARE RIGHT—OF—WAY SHALL BE IN ACCORDANCE WITH CURRENT STATE OF DELAWARE DEPARTMENT OF TRANSPORTATION STANDARD SPECIFICATIONS FOR ROAD AND BRIDGE CONSTRUCTION, SUPPLEMENTAL SPECIFICATIONS, STANDARD CONSTRUCTION DETAILS, SPECIAL PROVISIONS AND DESIGN GUIDANCE MEMORANDUMS.

3. ALL DISTURBED AREAS WITHIN THE STATE RIGHT-OF-WAY, BUT NOT IN THE PAVEMENT, SHALL BE TOP-SOILED (6" MINIMUM), FERTILIZED, SEEDED AND MULCHED.

4. A 72-HOUR (MINIMUM) NOTICE SHALL BE GIVEN TO THE DELDOT DISTRICT PERMIT SUPERVISOR PRIOR TO STARTING ENTRANCE CONSTRUCTION.

5. MISS UTILITY OF DELAWARE SHALL BE NOTIFIED THREE (3) CONSECUTIVE WORKING DAYS PRIOR TO EXCAVATION, AT 1-800-282-8555. 6. ALL SIGNING, STRIPING AND MAINTENANCE OF TRAFFIC IS THE CONTRACTOR'S RESPONSIBILTY AND SHALL FOLLOW THE GUIDLEINES SHOWN IN THE DELAWARE MANUAL ON UNIFORM TRAFFIC CONTROL DEVICES (DE MUTCD) FOR STREETS AND HIGHWAYS (LATEST EDITION). THE CITY OF NEWARK SHALL BE RESPONSIBLE FOR MAINTENANCE OF ALL SIGNS INSTALLED AS PART OF THIS PROJECT.

7. PLAN LOCATION AND DIMENSIONS SHALL BE STRICTLY ADHERED TO UNLESS OTHERWISE DIRECTED BY THE DELDOT DISTRICT PERMIT

8. A COPY OF THE UP TO DATE APPROVED CONSTRUCTION DOCUMENTS AND DELDOT APPROVAL LETTERS SHALL BE MAINTAINED ON THE PROJECT SITE AT ALL TIMES AND BE AVAILABLE FOR INSPECTION BY DELDOT PERSONNEL.

9. EXISTING UTILITIES ARE SHOWN IN ACCORDANCE WITH THE BEST AVAILABLE INFORMATION. COMPLETENESS OR CORRECTNESS THEREOF IS NOT GUARANTEED. IT SHALL BE THE CONTRACTOR'S RESPONSIBILITY TO CONTACT THE UTILITY COMPANIES INVOLVED IN ORDER TO SECURE THE MOST ACCURATE INFORMATION AVAILABLE AS TO UTILITY LOCATION AND ELEVATION, NO CONSTRUCTION AROUND OR ADJACENT TO UTILITIES SHALL BEGIN WITHOUT NOTIFYING THEIR OWNERS AT LEAST 48-HOURS IN ADVANCE. THE CONTRACTOR SHALL TAKE THE NECESSARY PRECAUTIONS TO PROTECT THE EXISTING UTILITIES AND MAINTAIN UNINTERRUPTED SERVICE AND ANY DAMAGE DONE TO THEM DUE TO HIS/HER NEGLIGENCE SHALL BE IMMEDIATELY AND COMPLETELY REPAIRED AT THE CONTRACTOR'S EXPENSE. TO LOCATE EXISTING UTILITIES IN THE FIELD PRIOR TO CONSTRUCTION, THE CONTRACTOR SHALL CONTACT MISS UTILITY OF DELAWARE (SEE NOTE #5).

10. SHOULD UTILITY RELOCATION BE REQUIRED, THE DEVELOPER MUST SUBMIT A UTILITY RELOCATION PLAN FOR DELDOT REVIEW, ALONG WITH CORRESPONDENCE FROM THE UTILITY COMPANIES STATING PRELIMINARY APPROVAL TO THE RELOCATION AND DESIGN OF THE UTILITIES PRIOR TO THE DELDOT PRE-CONSTRUCTION MEETING. NO PHYSICAL CONSTRUCTION CAN OCCUR UNTIL THE UTILITY PLANS ARE APPROVED, THE INDIVIDUAL UTILITY COMPANIES ISSUE FINAL APPROVAL, AND A DELDOT UTILITY PERMIT IS ISSUED.

11. DESIGN, FABRICATION AND INSTALLATION OF ALL PERMANENT SIGNING SHALL BE AS OUTLINED IN THE DE MUTCD.

12. DESIGN AND INSTALLATION OF ALL PAVEMENT MAKINGS AND STRIPING SHALL BE AS OUTLINED IN THE DE MUTCD, FOR FINAL PERMANENT PAVEMENT MARKINGS:

A) EPOXY RESIN PAINT SHALL BE REQUIRED FOR LONG LINE STRIPING B) THERMO WILL BE REQUIRED FOR SHORT LINE STRIPING, I.E. SYMBOLS/LEGENDS.

13. BREAKAWAY POSTS SHALL BE USED WHEN INSTALLING ALL SIGNS. REFERENCE DELDOT STANDARD CONSTRUCTION DETAIL T-15.

14. THE ENDS OF ALL CURBS SHALL BE DEPRESSED FLUSH WITH THE PAVEMENT AT A RATIO OF TWELVE TO ONE (12:1). TAPER CURB PER LOCAL DELDOT DISTRICT FIELD SUPERVISOR (TYPICAL FOR BOTH SIDES OF THE ENTRANCE).

15. A DOUBLE YELLOW CENTERLINE WILL BE REQUIRED ALONG THE PAVED PORTION OF PAPER MILL ROAD (N-13). STRIPING OF THE CENTERLINE SHALL BE 5-INCH WIDE LINE SEPARATED BY A 6-INCH SPACE.

16. VERIFY IF ANY UTILITIES WILL NEED TO BE RELOCATED DUE TO THE ADDITION OF THE SHOULDER. FOR CLEAR ZONE PURPOSES, ALL UTILITIES ARE TO BE A MINIMUM OF 10-FEET FROM THE EDGE OF TRAVEL LANE OR 5-FEET FROM THE EDGE OF PAVEMENT. ANY UTILITY THAT DOES NOT MEET THIS REQUIREMENT SHALL BE RELOCATED.

17. IT IS THE CONTRACTOR'S RESPONSIBILITY TO INSURE THAT PAVING WITHIN THE STATE OF DELAWARE RIGHT-OF-WAY IS INSTALLED TO THE ELEVATIONS SHOWN AND THAT NO PONDING OF WATER EXISTS AFTER PAVING IS COMPLETE,

18. ALL STORM DRAIN PIPING DESIGNATED AS RCP IS TO BE REINFORCED CONCRETE PIPE, MEETING AASHTO M-170 SPECIFICATIONS, SEE PLANS FOR SPECIFIC CLASS OF PIPE.

19. DRIVEWAYS WILL NOT BE PERMITTED TO BE PLACED AT CATCH BASIN LOCATIONS,

20. THE DEVELOPER EXISTING/FUTURE OWNER OF NON-STATE-MAINTAINED ROADWAYS SHALL ENSURE THAT THE TRAFFIC CONTROL DEVICES ON SAID ROADWAYS OPEN TO PUBLIC TRAVEL ARE IN COMPLIANCE WITH THE DELAWARE MUTCD.

21. CONTRACTOR SHALL SUPPLY MESSAGE BOARDS THAT ARE TO BE PLACED TEN (10) DAYS PRIOR TO CONSTRUCTION ALONG PAPER MILL ROAD. THE PROPER WORDING ON THE MESSAGE BOARD WILL NEED TO BE COORDINATED WITH THE DISTRICT SAFETY OFFICER.

22. WARM MIX ASPHALT (WMA) SHALL BE PLACED IN ACCORDANCE WITH DELDOT SPECIAL PROVISION(S) 401801, 401807, 401816 AND 401819 - WMA SUPERPAVE.

TOA RECOMMENDATIONS

AS PER THE TRAFFIC OPERATIONAL ANALYSIS FOR CURTIS PAPER MILL PARK DATED JULY 2012, THE FOLLOWING ITEMS SHOULD BE INCORPORATED INTO THE SITE DESIGN AND REFLECTED ON THE RECORD PLAN. ALL APPLICABLE AGREEMENTS (I.E., LETTER AGREEMENTS FOR OFF-SITE IMPROVEMENTS AND TRAFFIC SIGNAL AGREEMENTS) SHOULD BE EXECUTED PRIOR TO ENTRANCE PLAN APPROVAL FOR THE

. PROVIDE ONE ENTERING LANE AND ONE EXISTING LANE FOR THE SITE DRIVEWAY WHICH WILL FORM THE 4TH LEG OF THE SIGNALIZED

2. PROVIDE A NORTHBOUND LEFT-TURN LANE ON PAPER MILL ROAD WITH 75 FEET OF STORAGE.

3. RESTRIPE THE WESTBOUND APPROACH OF OLD PAPER MILL ROAD TO FORM A SHARED LEFT/THROUGH LANE AND A SEPARATE RIGHT-TURN LANE.

4. PROVIDE PEDESTRIAN CROSSWALK AND PEDESTRIAN SIGNAL EQUIPMENT ACROSS THE NEW EASTBOUND APPROACH.

5. UPGRADE SIGNAL EQUIPMENT/DESIGN TO ACCOMMODATE THE NEW INTERSECTION GEOMETRY.

ADJUST SIGNAL PHASING AND TIMINGS TO ACCOMODATE THE NEW INTERSECTION GEOMETRY.


NEWARK, DE


PAPER MILL ROAD (N-13) AND OLD PAPER MILL ROAD (N-310) DATE: DECEMBER 14, 2012


PREPARED FOR:

CITY OF NEWARK

220 SOUTH MAIN STREET **NEWARK**, **DE 19711**

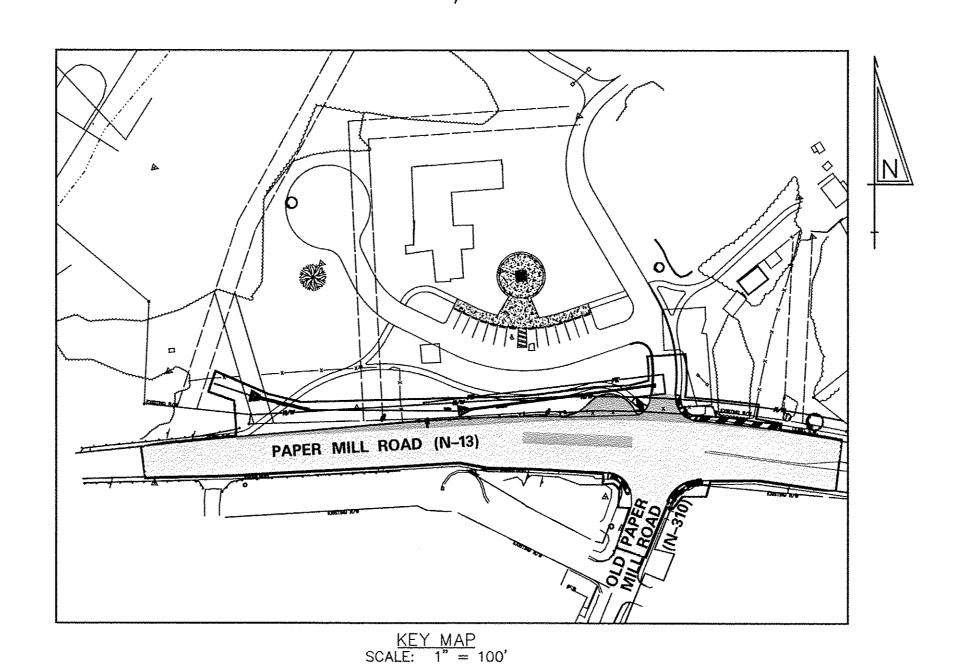


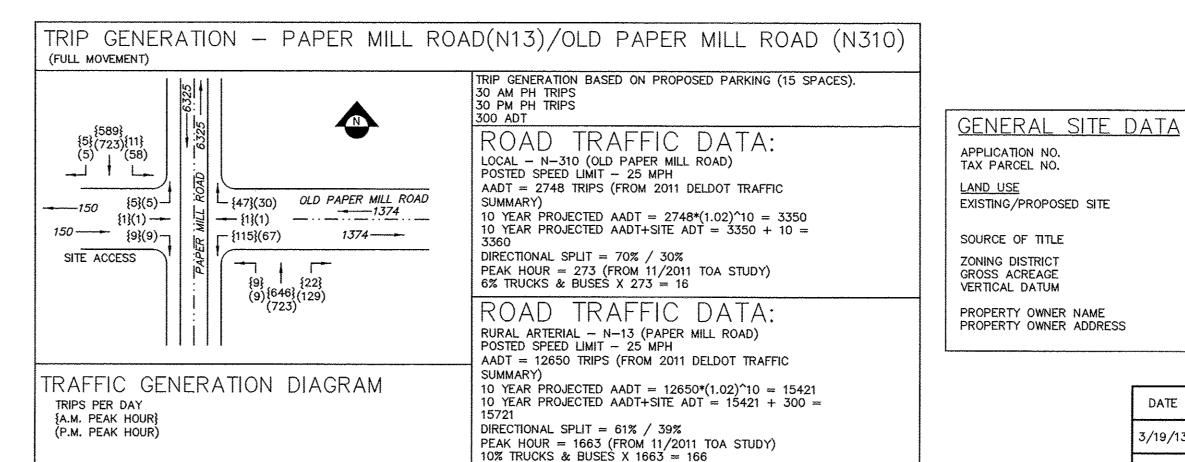

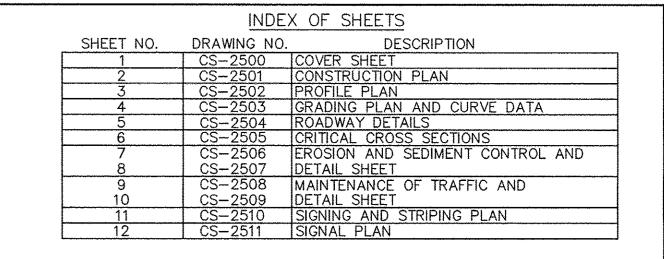

LEGEND

	EXISTING	PR	OPOSED			
	MONUMENT FOUND		LIMIT OF DISTURBANCE			
	P.K. NAIL FOUND	-roc-	LIMIT OF CONSTRUCTION PHASING LINE			
	BENCHMARK	\bigcirc	PHASING NUMBER			
(C)	TREE	\bigcirc	NUMBER OF PARKING SPACES			
G	GAS VALVE GAS METER	A 4.	CONCRETE			
E E	UNDERGROUND		BUILDING BUILDING CANOPY			
0	GAS MARKER GAS MANHOLE		CURB			
	GAS LINE		FLUSH/DEPRESSED CURB			
B.H	BOLLARD BORE HOLE	and Charles and Charles and Charles Str.	CURB AND GUTTER TYPE 3			
MWO	MONITORING WELL	apiapiapiapiapiapi •	CURB TO BE REMOVED BOLLARD			
Ш	TELEPHONE BOX	384	MINOR CONTOUR			
<u> </u>	TELEPHONE MANHOLE TELEPHONE POLE	—385— x <u>3</u> 84.25	MAJOR CONTOUR SPOT GRADE			
TP'Q	- TELEPHONE LINE		DRAINAGE INLET DRAINAGE MANHOLE			
PWR	POWERPOLE		STORMTECH ISOLATOR ROW			
~	GUY WIRE		STORM SEWER			
`\ <u>\</u>	LIGHT POLE	© −CN-S−	SANITARY MANHOLE SANITARY SEWER			
Ø-0	STREET LIGHT POLE	-CN-E- -DP-G-	ELECTRIC SERVICE			
	BURIED ELECTRIC	-VER-C-	GAS SERVICE TELEPHONE SERVICE			
O/HE (E)	OVERHEAD ELECTRIC ELEC. MANHOLE	-CN-W-	WATER SERVICE WATER VALVE			
	ELECTRIC METER		LEVEL SPREADER			
_	WATER LINE	IP (2)	TYPE 2 INLET PROTECTION			
	WATER MANHOLE WATER VALVE	—SF —	SILT FENCE			
凼	WATED METED	—EЕ —	EROSION EEL			
	HIURANI PO	SCE S	STABILIZED CONSTRUCTION ENTRANCE			
₽F.	PREVENTOR (2)		STADICIZED GONSTROOTION ENTRANGE			
\$S	SAN.SEWER LINE	BRL	BUILDING RESTRICTION LINE			
	SEWER MANHOLE	↔	SIGN			
c / 2	CLEAN OUT		5" SOLID WHITE STRIPE 5" SOLID DOUBLE YELLOW STRIPE			
	STORM DRAIN LINE STORM DRAIN MANHOLE		5" DASHED WHITE STRIPE			
SI	STORM INLET		ADEA OF MILL AND OVERLAY			
			AREA OF MILL AND OVERLAY			
x383.27	SPOT GRADE		AREA OF FULL DEPTH PAVEMENT			
	- EXISTING RIGHT-OF-WA	Y -R/W-	PROPOSED RIGHT-OF-WAY			
	STONE CHECK DAM		INLET SEDIMENT CONTROL			
	ROCK OUTLET PROTECTION		SIDEWALK, MIN. 4" CEMENT CONCRETE PAVEMENT (3000 PSI) OVER 4" G.A.B.C.			
LITHITY HOED HOT						
<u>UTILITY USER LIST</u>						

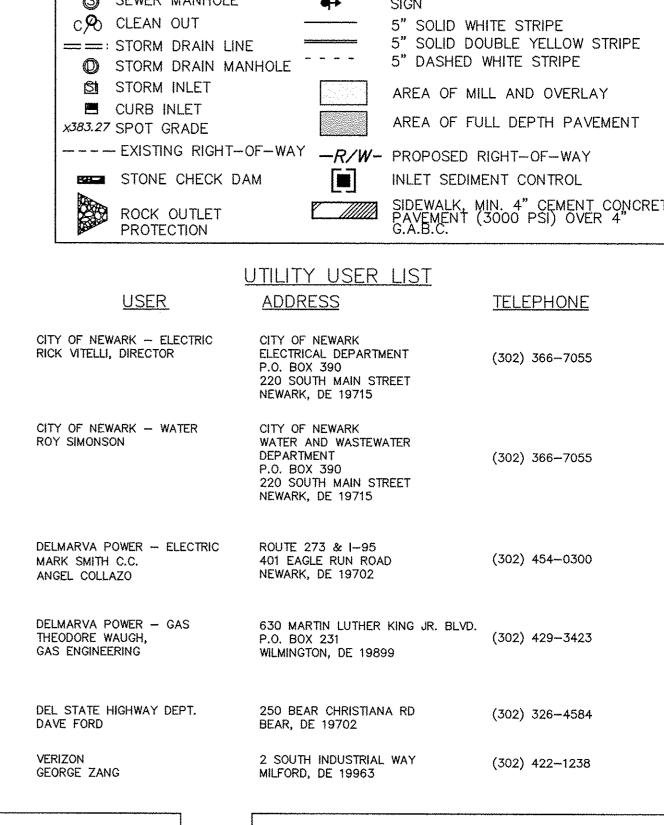

CONSULTING ENGINEERS 121 CONTINENTAL DRIVE - SUITE 207 No. 12429 NEWARK, DELAWARE 19713 PHONE: 302-655-4451 FAX: 302-654-2895 9.26 2013 SIGNATURE

			APPRO'
NO.	REVISIONS	BY	, ,
1	ADDRESS COMMENTS FROM PRELIMINARY ENTRANCE REVIEW	KMS	
2	ADDRESS COMMENTS FROM SEMI-FINAL ENTRANCE REVIEW	KMS	SIGNATURE
7	ADDRESS COMMENTS FROM	14.40	

FINAL ENTRANCE REVIEW

18-014.00-266

225 PAPER MILL RD

DEED RECORD 2645-300

NEWARK, DE 19711

7.38 AC.

3/19/13

7/11/13

9/26/13

NAVD 1988

P.O. BOX 39

CITY OF NEWARK


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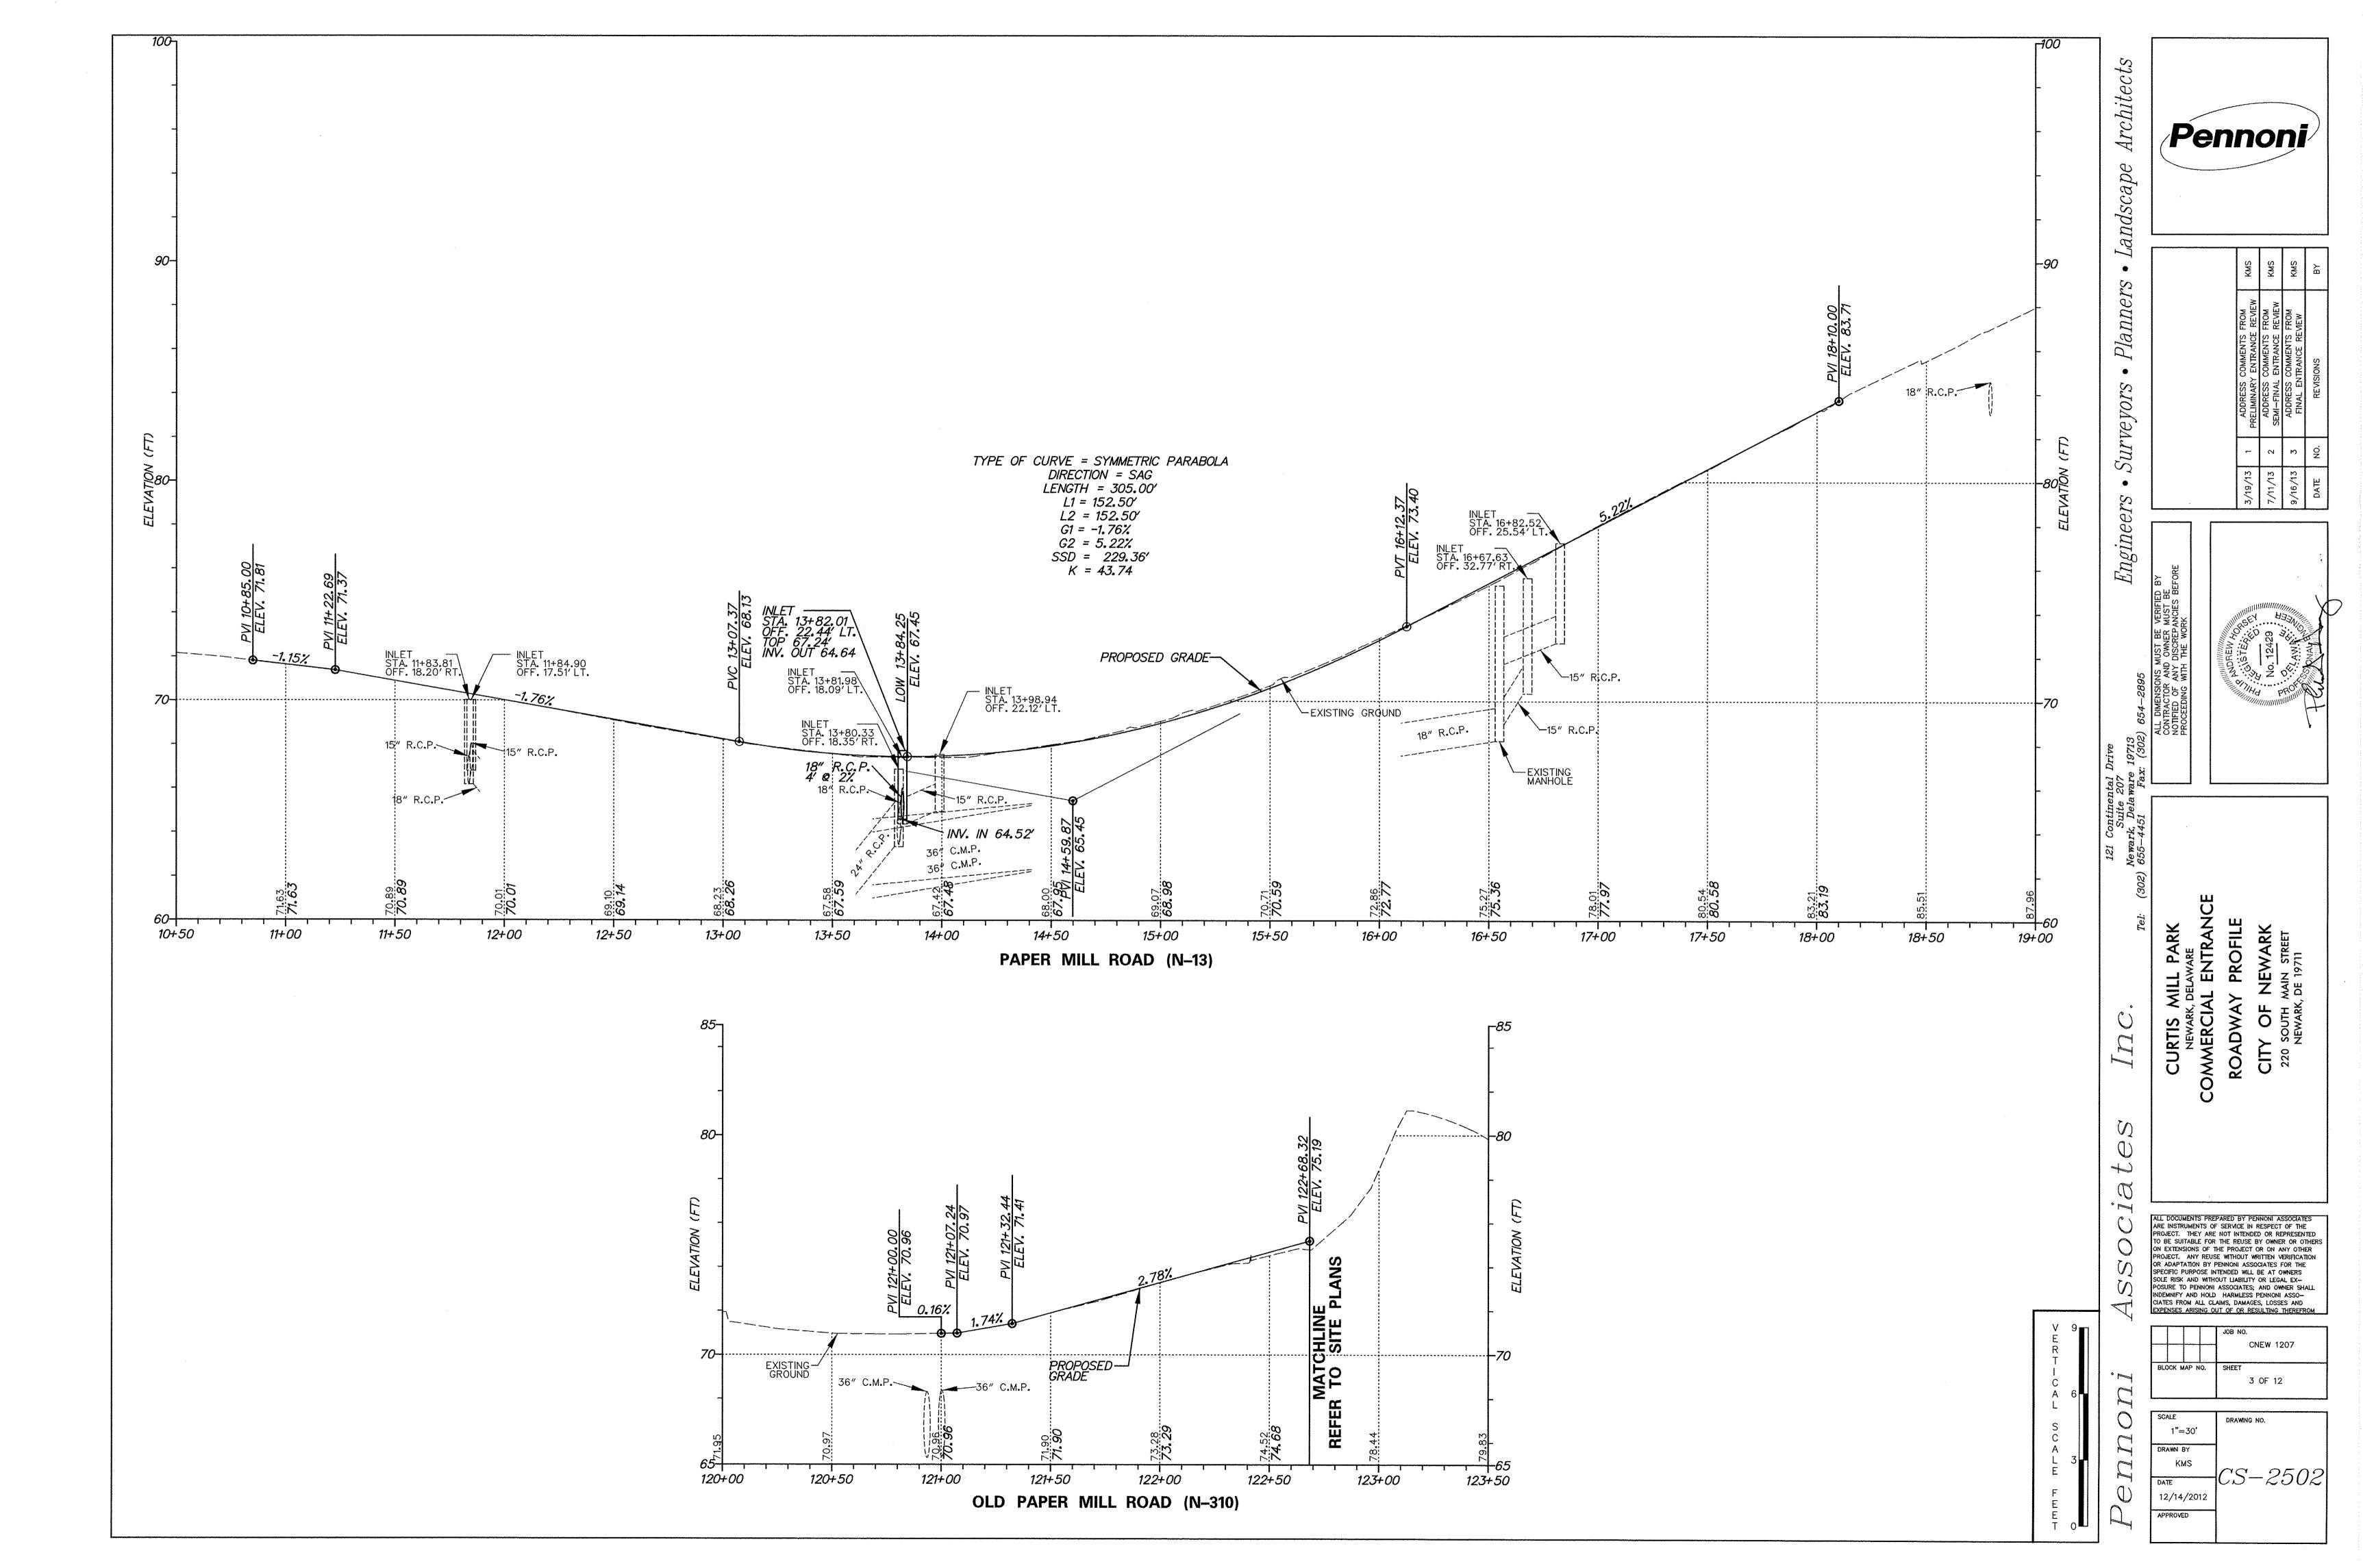
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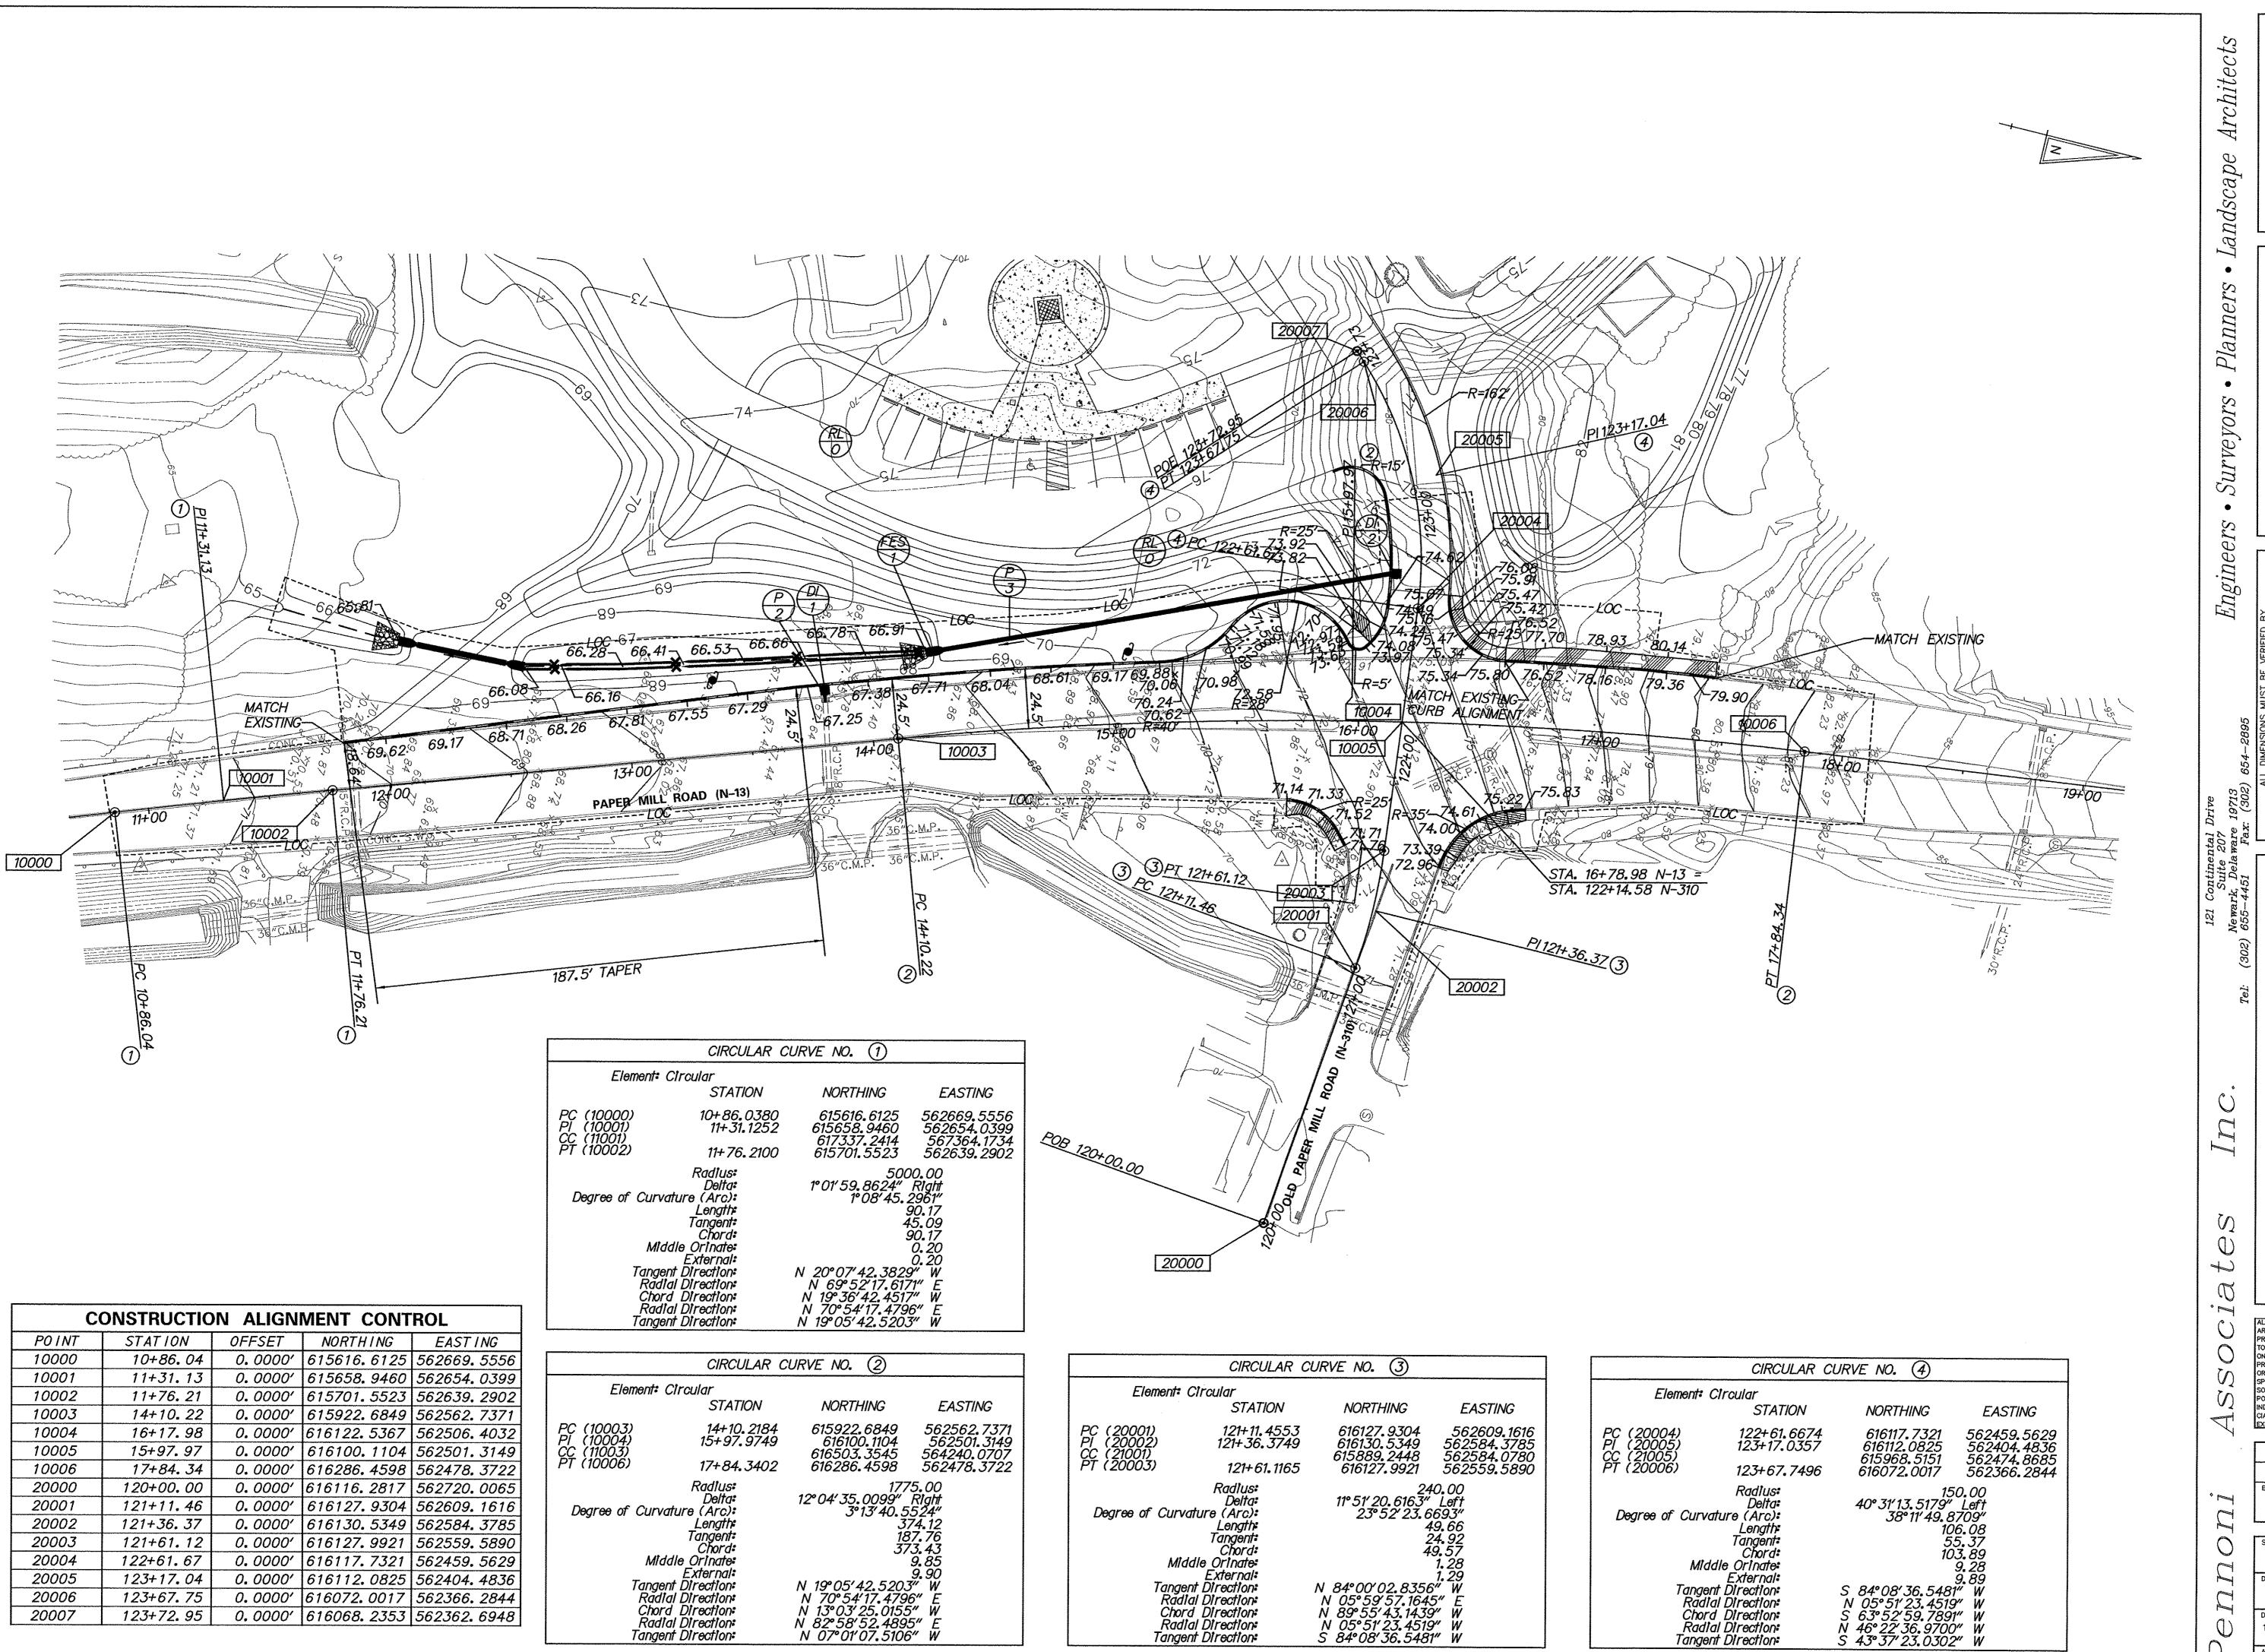
PREPARED BY

PENNONI ASSOCIATES INC.

DATE





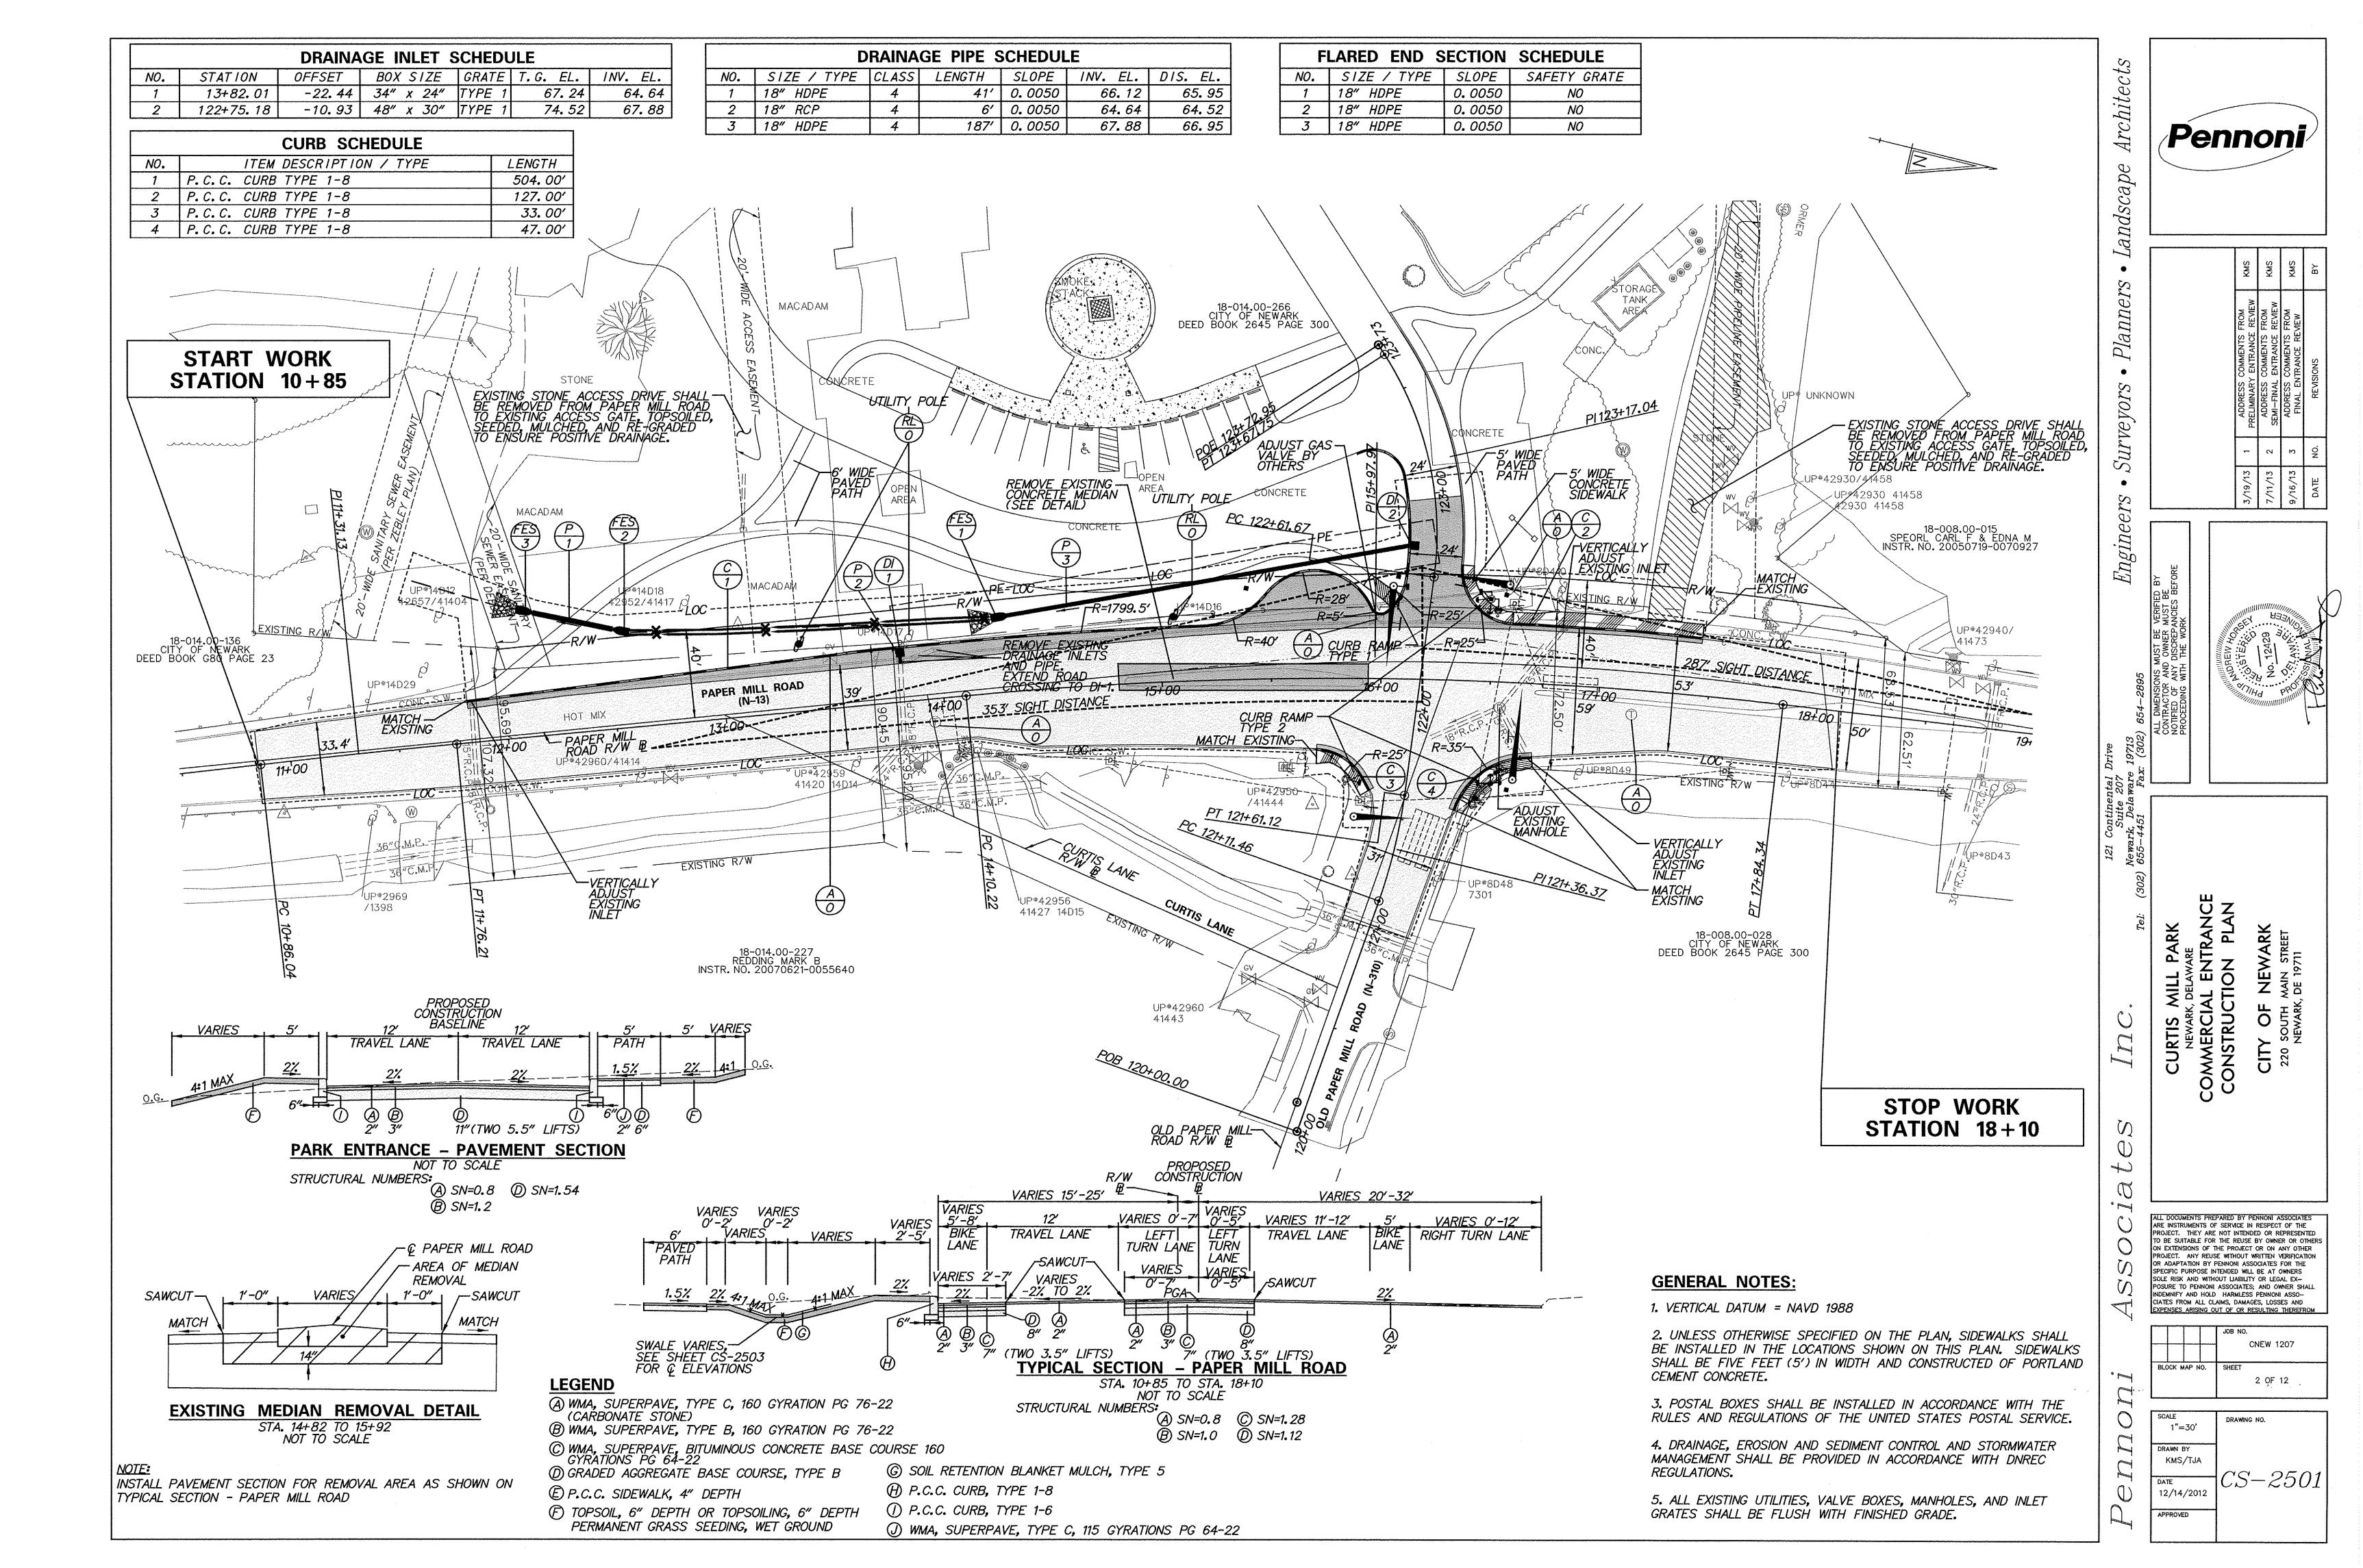



DIMENSIONS MUST BE VERIFIED BY
TRACTOR AND OWNER MUST BE
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CURTIS MILL PARK

NEWARK, DELAWARE

COMMERCIAL ENTRANCE


ING PLAN AND CURVE DATA

CITY OF NEWARK

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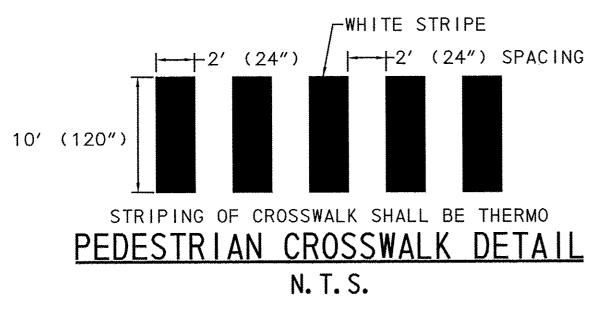
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	ЈОВ NO. CNEW 1207
BLOCK MAP NO.	SHEET 4 OF 12


SCALE 1"=30'	DRAWING NO.
DRAWN BY KMS/TJA	
DATE 12/14/2012	CS-2502
APPROVED	

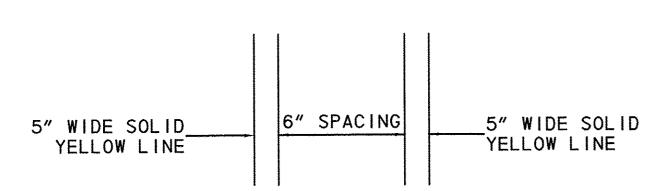


NOTE: STRIPING SHALL BE

DOUBLE YELLOW LINE STRIPING DETAIL N. T. S.




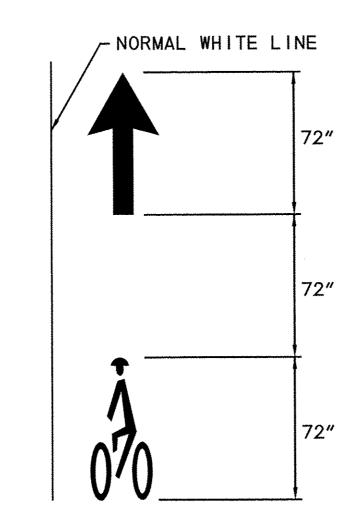

BICYCLE LANE PAVEMENT MARKING SYMBOL N. T. S.

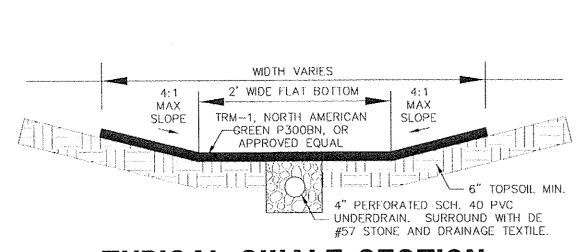


TYPICAL SWALE SECTION SCALE: N.T.S.

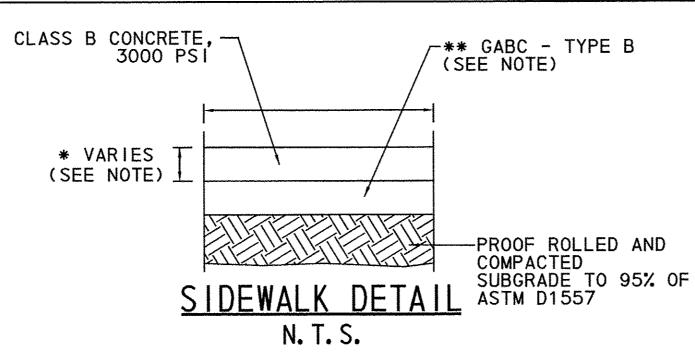

* - STANDARD SIDEWALK SHALL BE 4" THICK. FOR DEPRESSED AND TRANSITION AREA, THE SIDEWALK SHALL BE 6" THICK. ** - STANDARD SIDEWALK OF 4" THICKNESS SHALL BE PLACED OVER 4" GABC TYPE B. SIDEWALK FOR DEPRESSED AND TRANSITION AREAS OF 6" THICKNESS SHALL BE PLACED OVER 6" GABC TYPE B.

MARK IN 5' SQUARES, USE CORK EXPANSION JOINTS AT INTERVALS NOT GREATER THEN 15'.
2. CONCRETE SIDEWALKS SHALL BE CONSTRUCTED AS PER DELDOT SPECIFICATIONS. 3. SIDEWALK TO BE CONSTRUCTED AT GRADE. SLOPE OF SIDEWALK SHALL BE AT A 1.5% SLOPE WITH A 2% MAX/1% MIN IN ORDER TO ASSURE POSITIVE DRAINAGE.

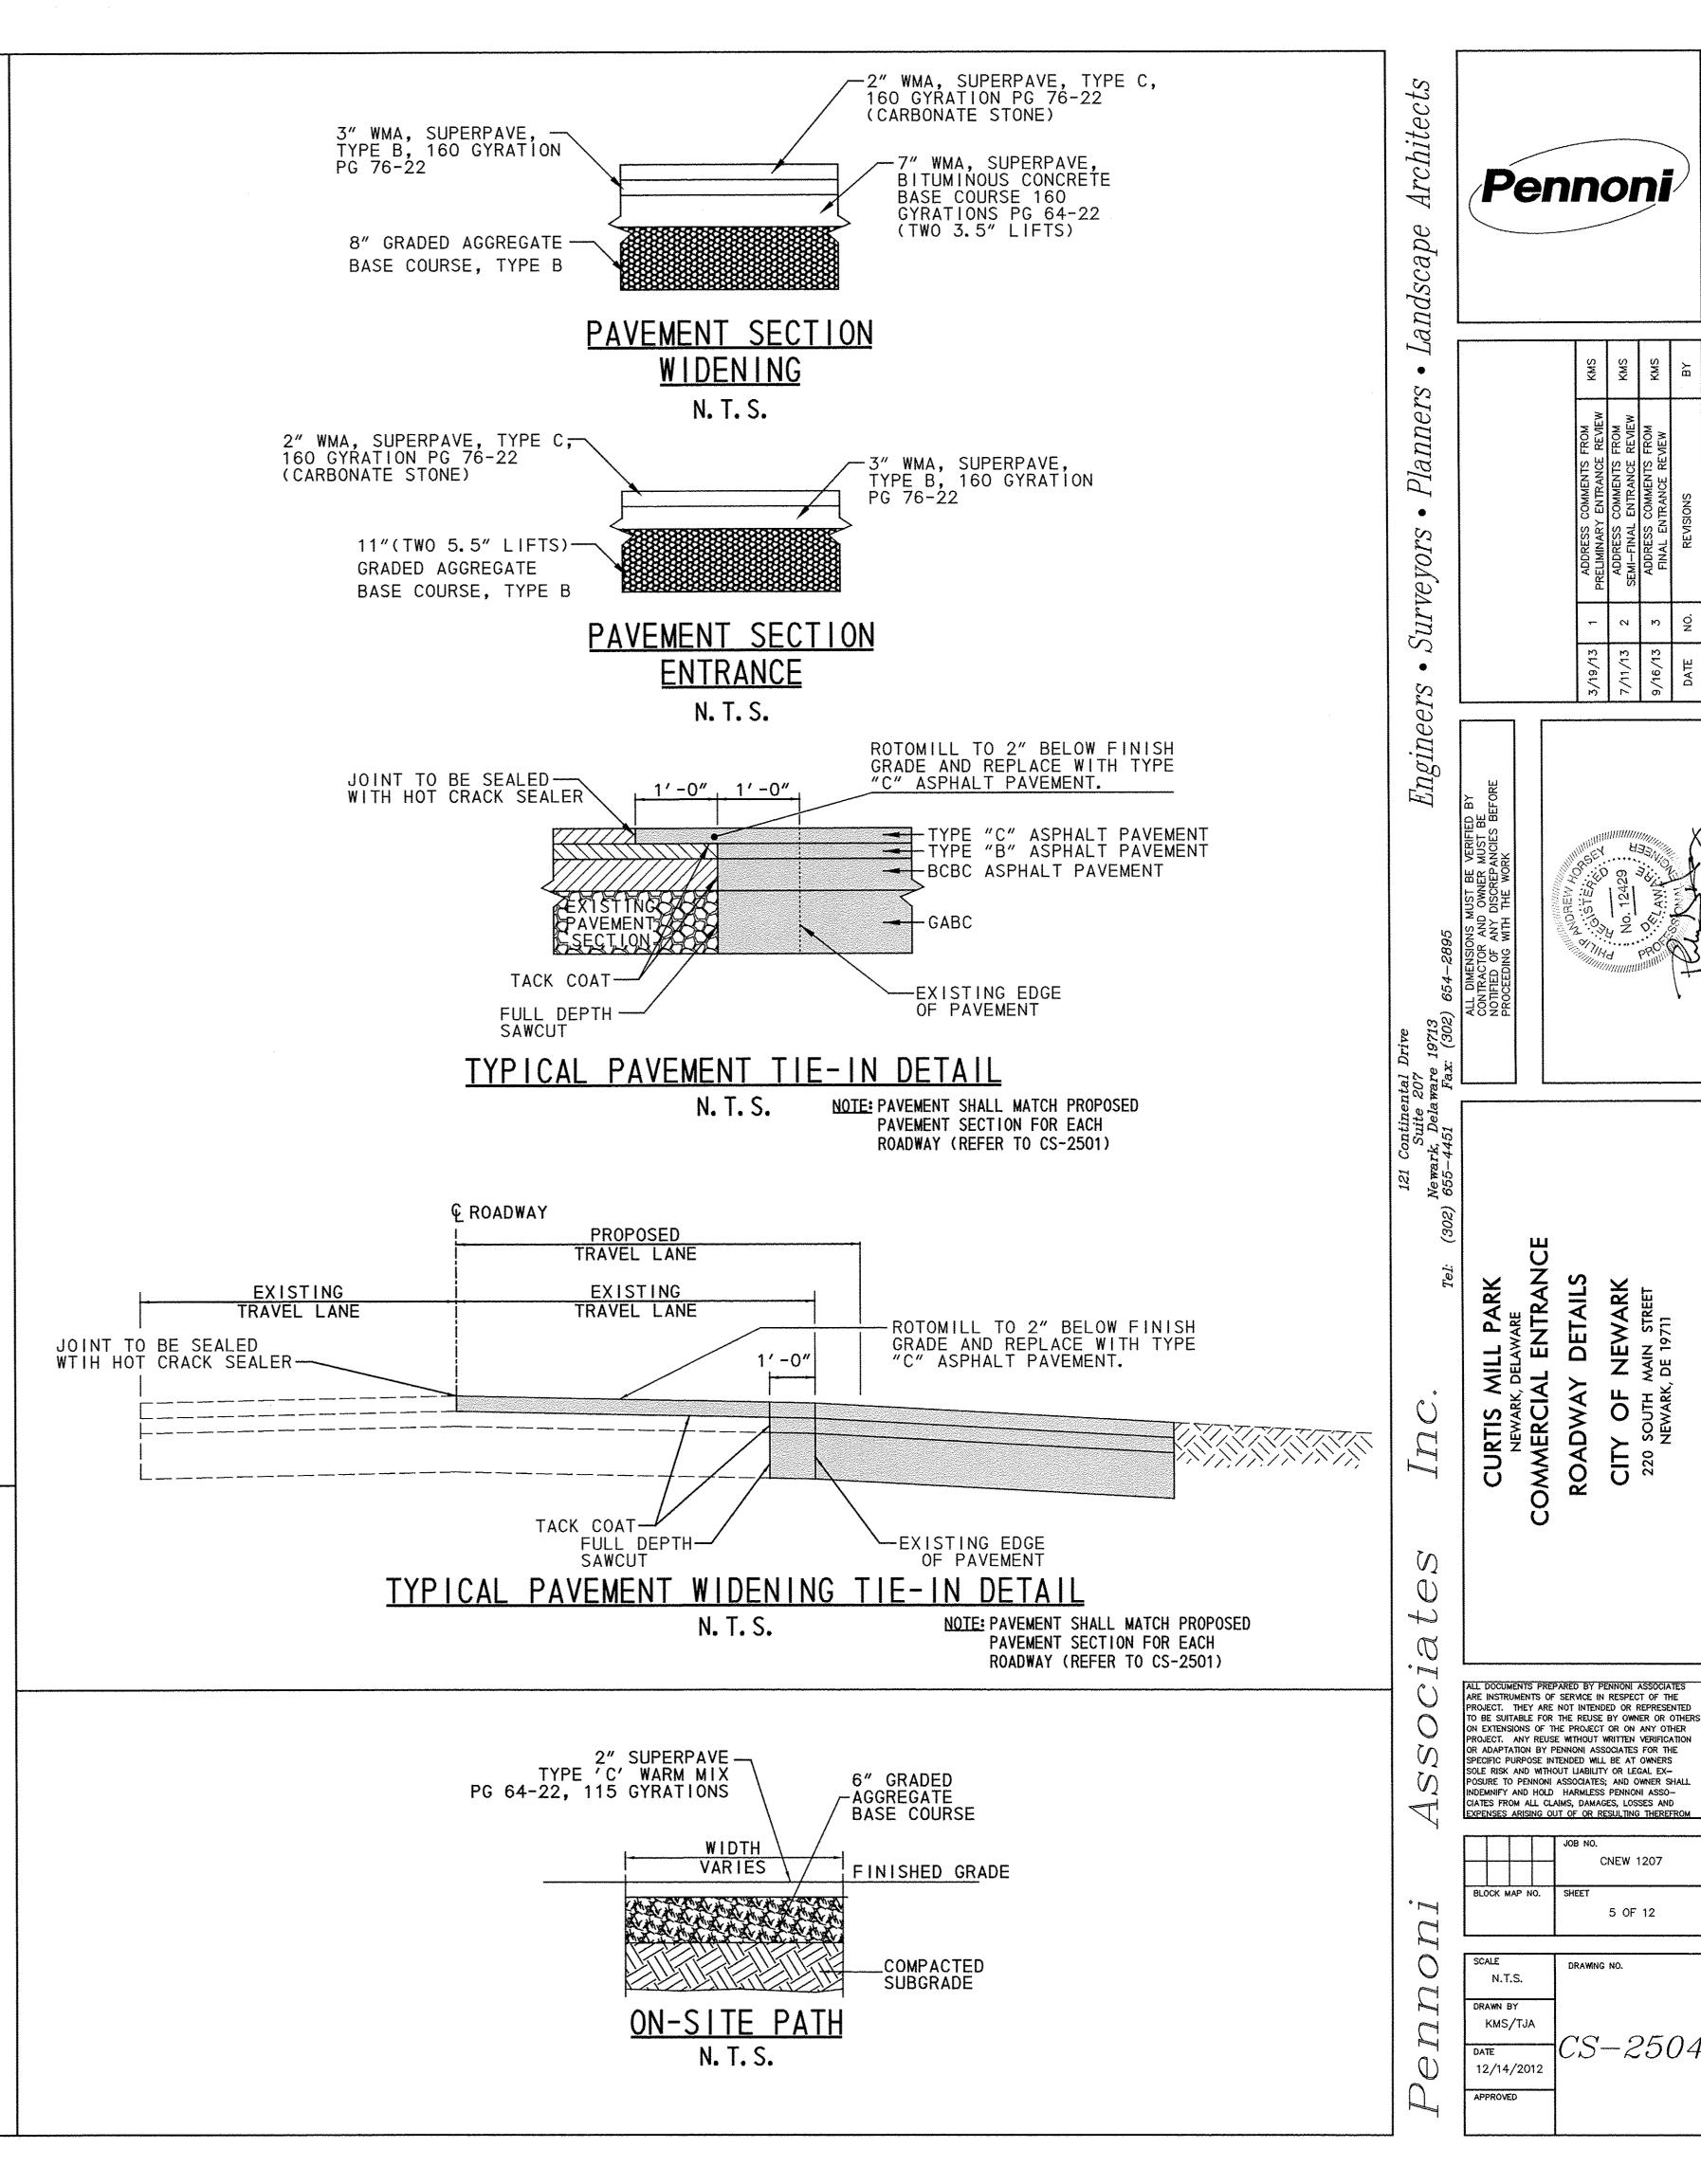



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5 OF 12

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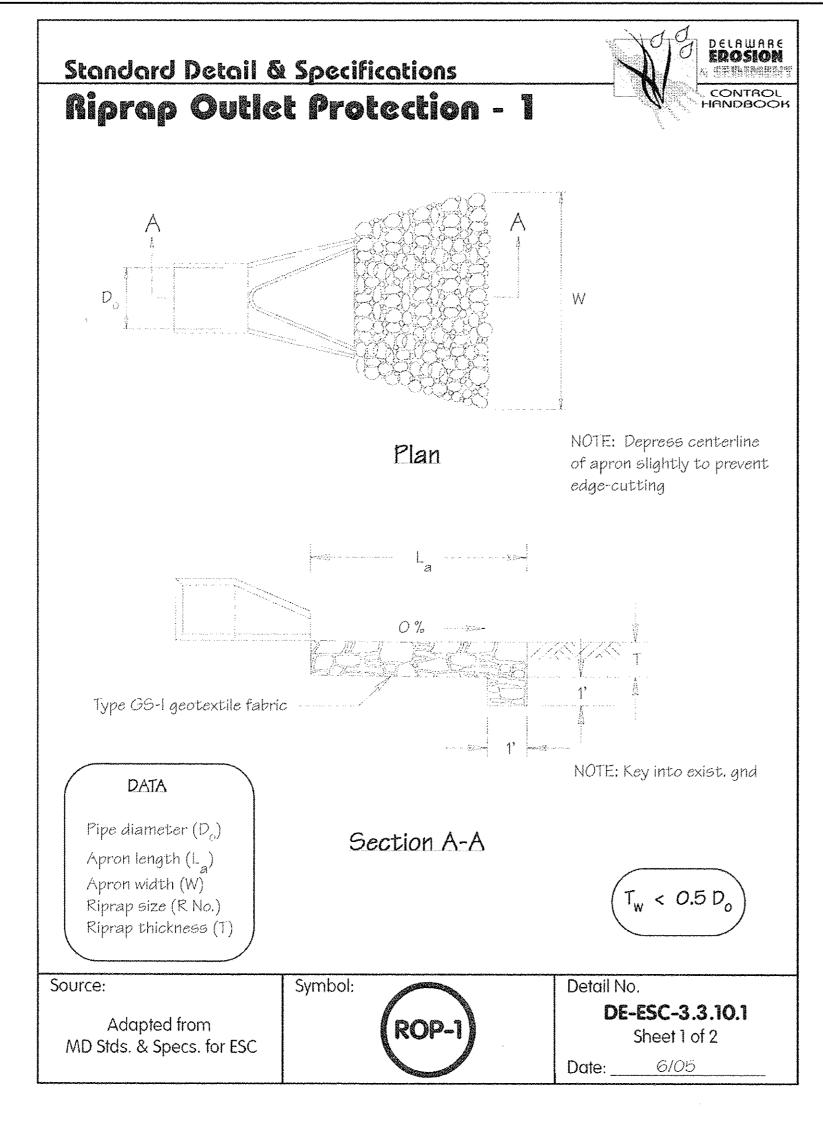
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/Pennoni/

SOLE RISK AND WITHOUT LIABILITY OR LEGAL EXPOSURE TO PENNONI ASSOCIATES; AND OWNER SHALL
INDEMNIFY AND HOLD HARMLESS PENNONI ASSOCIATES FROM ALL CLAIMS, DAMAGES, LOSSES AND
EXPENSES ARISING OUT OF OR RESULTING THEREFROM



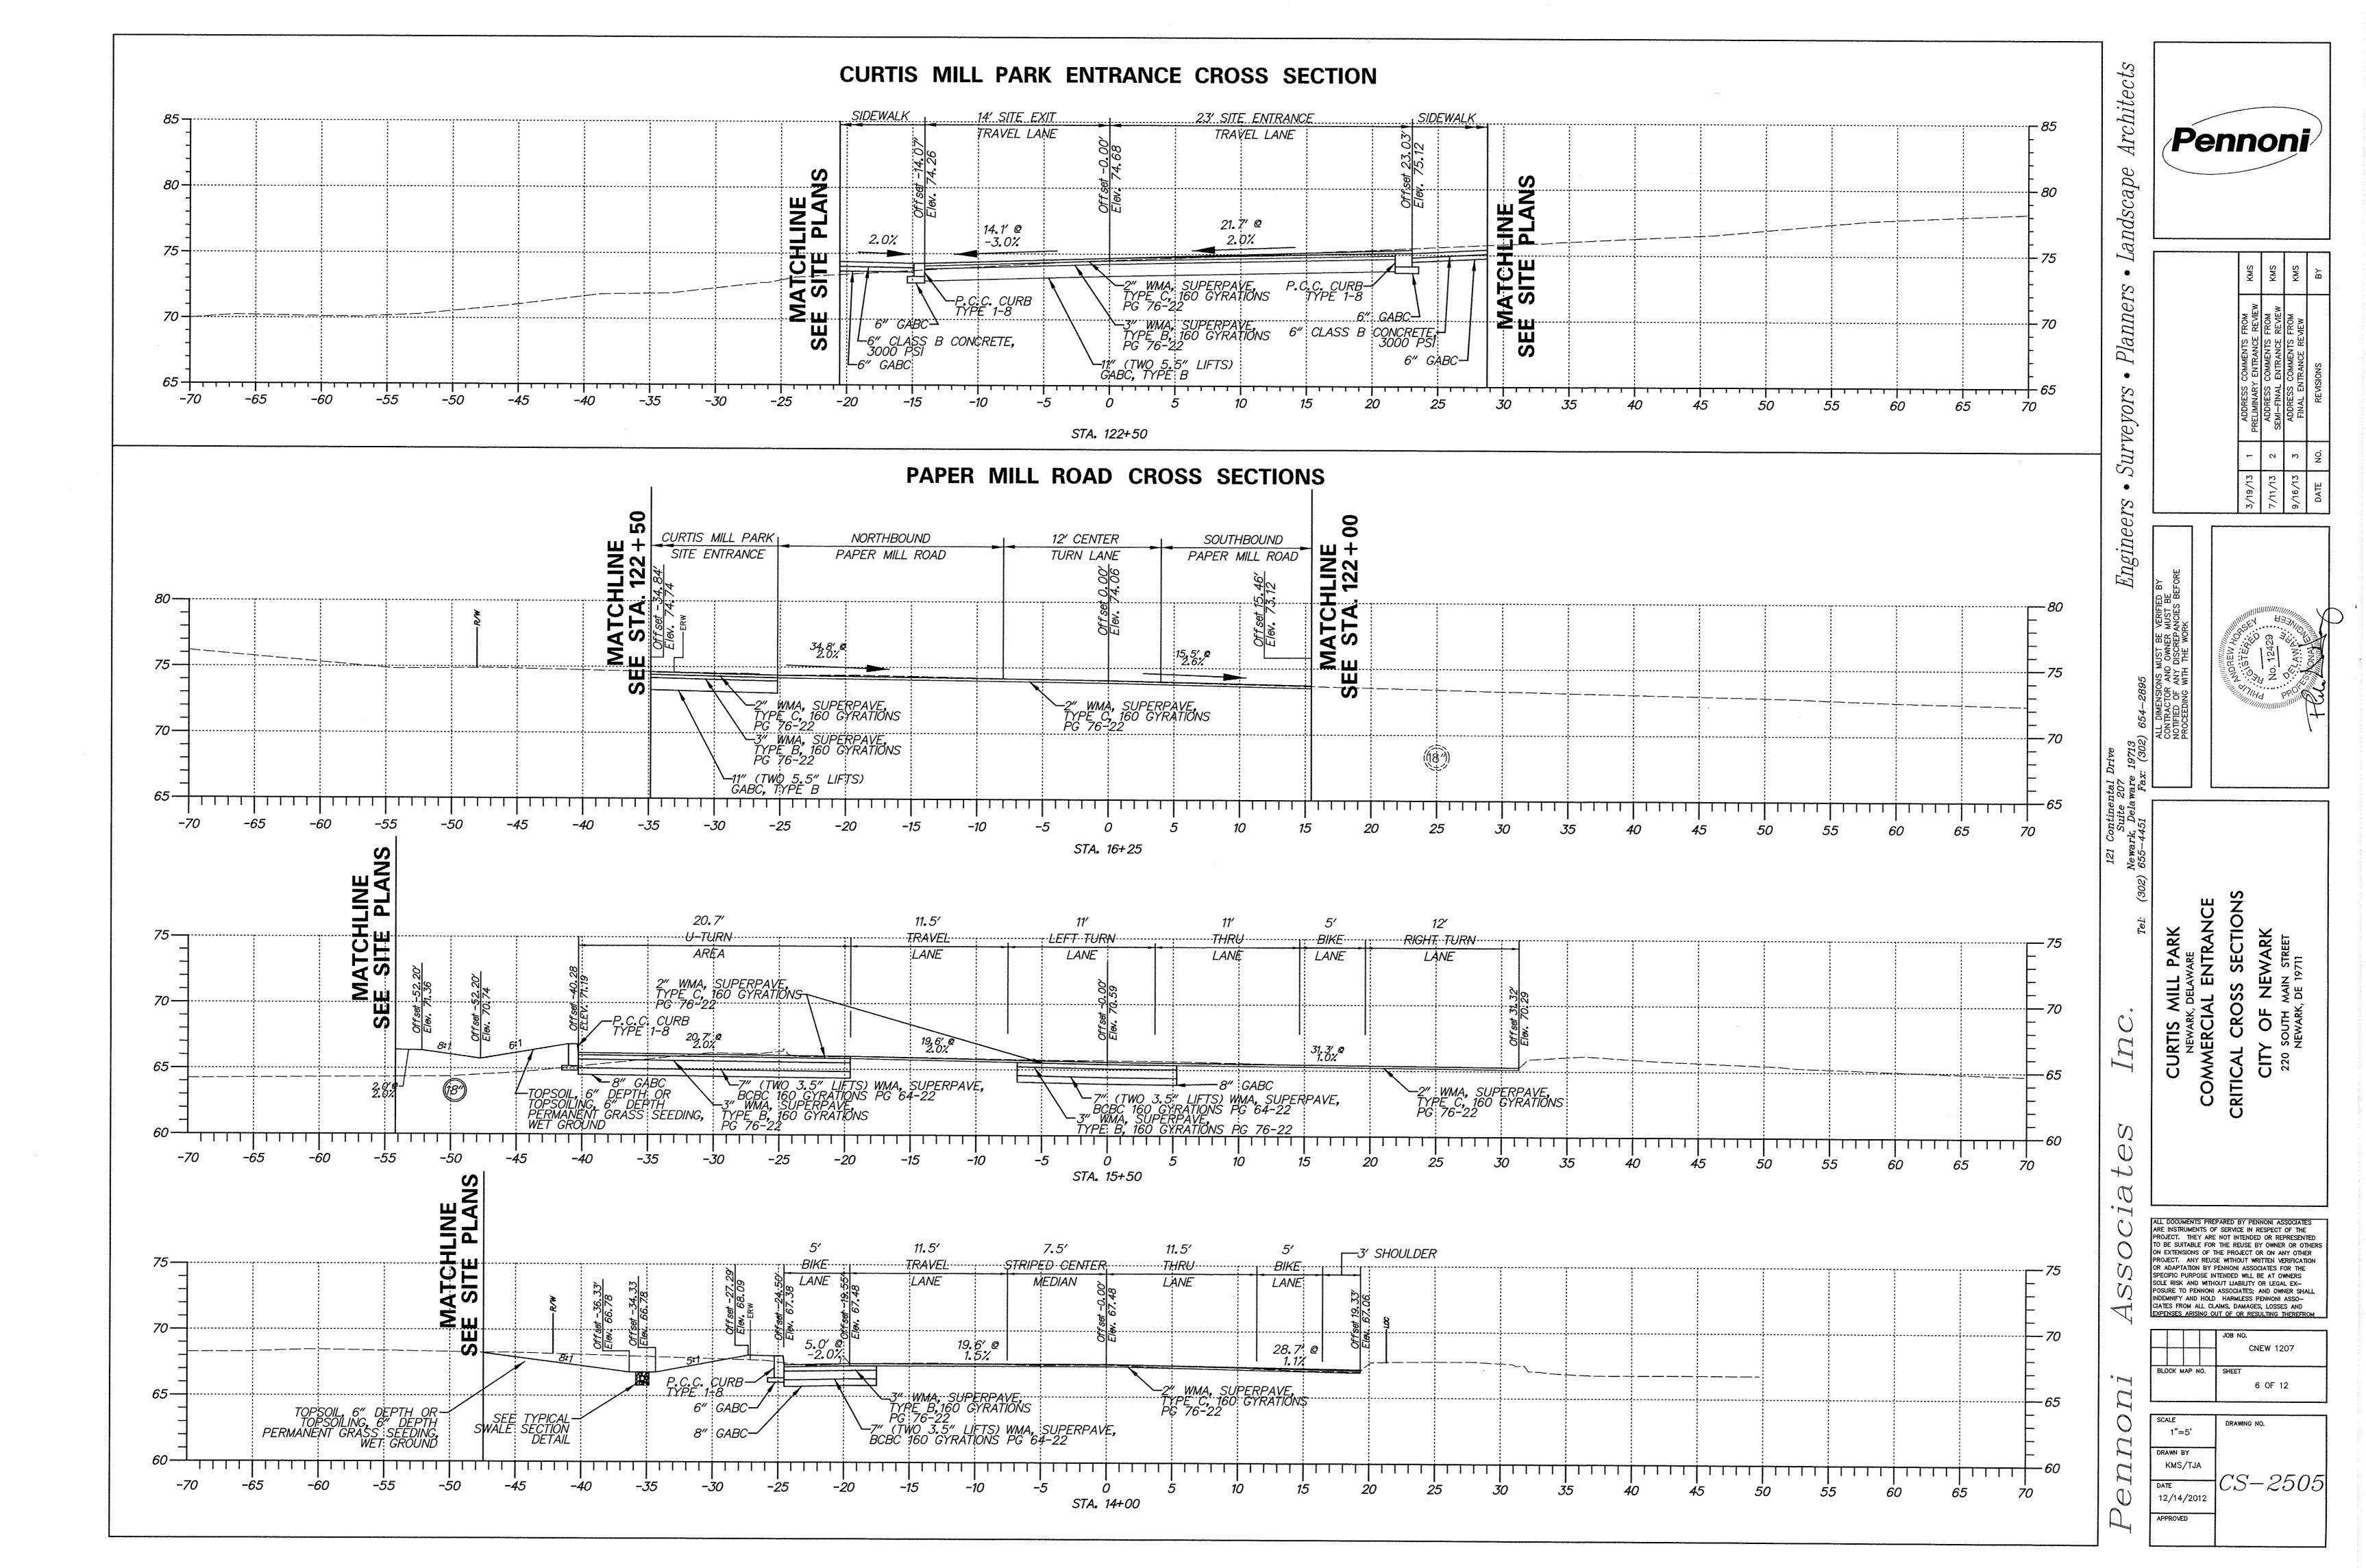

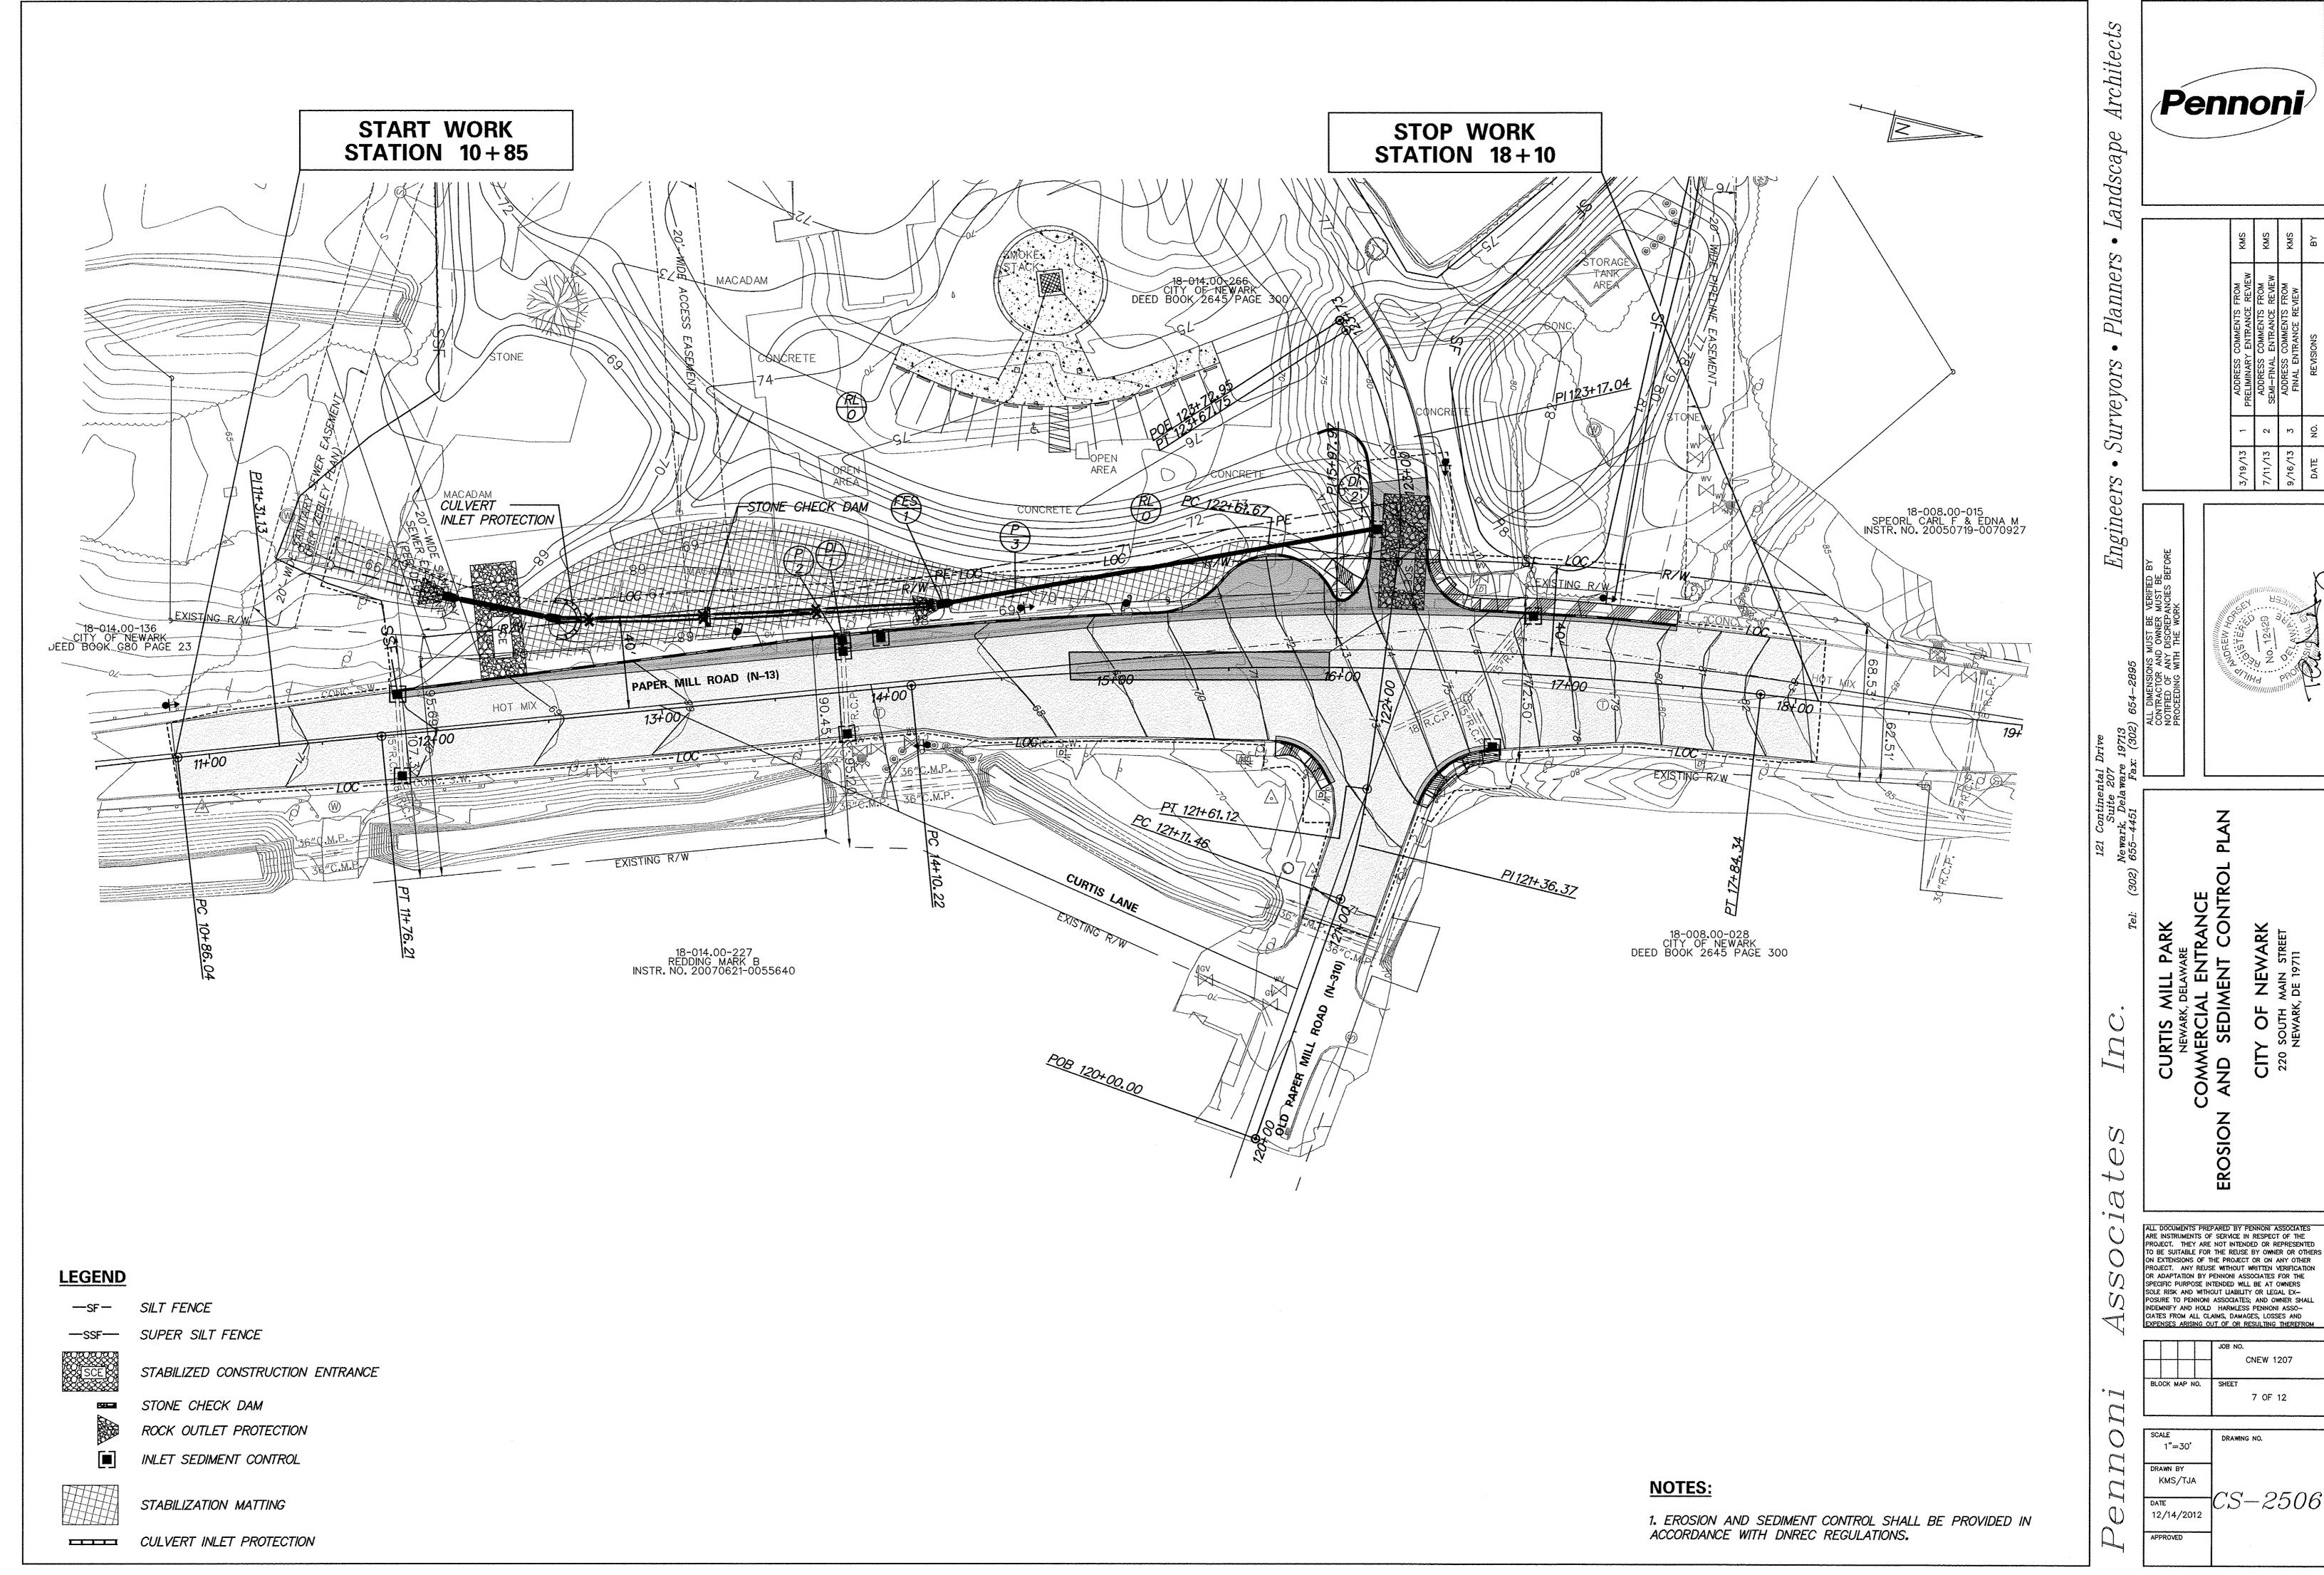Standard Detail & Specifications Riprop Outlet Protection - I

Construction Notes:

- 1. The subgrade for the riprap shall be prepared to the required lines and grades as shown on the plan. Any fill required in the subgrade shall be compacted to a density of approximately that of the surrounding undisturbed material.
- 2. The riprap shall conform to the grading limits as shown on the plan.
- 3. Filter cloth shall be protected from punching, cutting or tearing. Any damage other than an occasional small hole shall be repaired by placing another piece of cloth over the damaged area. All connecting joints should overlap a minimum of 1 ft. If the damage is extensive, replace the entire filter cloth.
- 4. Stone for the riprap or gabion outlets may be placed by equipment. Riprap shall be placed in a manner to prevent damage to the filter cloth. Hand placement will be required to the extent necessary to prevent damage to the conduits, structures, etc.

***************************************	ROCK OL	JTLET PR	OTECTION	DATA:
	FES-1		FES-3	
-	Do= La= W= R No.= T=	18" 10' 11.5' 4 14"	Do= La= W= R No.= T=	18" 10' 11.5 4 14"

Source:

EROSION

DE-ESC-3.1.6

Sheet 1 of 2

03/13

Date: _

Adapted from MD Stds. & Specs. for ESC

DE-ESC-3.3.10.1 Sheet 2 of 2

6/05 Date:

EROSION

0.402.48.19405t. - F#SID#SOTEM

Standard Detail & Specifications Culvert Inlet Protection

Construction Notes

- 1. Compost logs shall be designed and installed in accordance with the Standard Detail and Specifications for Compost Logs (DE-ES-3.1.7).
- 2. If compost logs can not be installed properly or flow conditions exceed the design capabilities of the compost logs, the stone option shall be employed. Additional filtration may be provided by using a Type GD-II geotextile incorporated into the design as an
- 3. Placement of the compost log or stone barrier should be in a "horseshoe" shape and provide a minimum of 6 feet of clearance from the culvert inlet.

Materials

- Stakes: 2" x 2" x 36" hardwood.
- Compost media: See requirements in Standard Detail and Specifications for Compost
- Filter sock: See requirements in Standard Detail and Specifications for Compost Logs (DE-ES-3.1.7).
- Geotextile: Type GD-II for stone/riprap option.
- Stone: DE No. 3 for stone/riprap option.
- Riprap: R-6 for stone/riprap option.

Source: Symbol: Detail No. **DE-ESC-3.1.6** Adapted from CIP Sheet 2 of 2 VA ESC Handbook & FiltrexxTM International 03/13 Date:



Surveyors

Engineers

CURTIS

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CIATES FROM ALL CLAIMS, DAMAGES, LOSSES AND EXPENSES ARISING OUT OF OR RESULTING THEREFROM CNEW 1207 BLOCK MAP NO.

DRAWING NO. 1"=30" KMS/TJA 12/14/2012

Exceso sock material must be staked into the toe of slope on both sides to prevent by-pass flow. The log shall extend upwards of the maximum water surface elevation. 2" x 2" x 36" hardwood stake placed 5' on center 18" compost log (see Compost Filter Log specifications for additional information). Stone option may also be used; reference section below. Plan View - Compost Log Option DE No. 3 stone Type GD-II geotextile fabric Section View - Stone Option Source: Symbol: Detail No.

CIP

Standard Detail & Specifications

Culvert inlet Protection

Adapted from

VA ESC Handbook

& Filtrexx[™] International

DE MUTCD

that roadway will encounter another advance warning sign prior to the activity area. 3. For short duration operations of 60 minutes or less, all signs and channelizing devices may be eliminated if a vehicle with activated high-intensity rotating, flashing, oscillating, or strobe lights is used.

4. When paved shoulders having a width of 8 feet or more are closed, at least one advance warning sign shall be used. In addition, channelizing devices shall be used to close the shoulder in advance to delineate the beginning of the work space and direct vehicular traffic to remain within the traveled way. 5. If the shoulder closure is located within a passing zone, ROAD WORK AHEAD and END ROAD WORK signs shall be placed for traffic approaching in the opposite direction.

6. For long-term, intermediate-term, and short-term operations, a truck-mounted attenuator shall be used on roadways with a posted speed limit or 85th-percentile speed greater than 40 mph.

7. If the shoulder closure is located within a no-passing zone, ROAD WORK AHEAD and END ROAD WORK signs may be placed for traffic approaching in the opposite direction based on engineering judgment. 8. For short duration operations along roadways with a posted speed limit or 85th-percentile speed greater than 40 mph, a truck-mounted attenuator may be omitted if a vehicle with activated high-intensity rotating, flashing, oscillating, or strobe lights is used or if the shoulder width is less than the width of a truck-mounted attenuator.

9. Truck-mounted attenuators may be used for all operations along roadways with a posted speed limit or 85th-

Figure 6H-3. Work on the Shoulder of a Two-Lane Road (TA-3) (Delaware Revision) ROAD WORK Truck-mounted attenuator (see Notes 6, 8, & 9) Shoulder taper (see Note 4) Note: See Tables 6H-2 and 6H-3 for the meaning of the symbols and/or letter codes used in this figure. Truck-mounted attenuator (see Notes 6, 8, & 9) Shoulder taper (see Note 4) ROAD WORK END **Typical Application 3**

Revision 1, December 2012

Page 6H-35

Page 6H-15

Revision 1, December 2012

percentile speed less than or equal to 40 mph.

Notes for Figure 6H-10—Typical Application 10 Lane Closure on a Two-Lane Road Using Flaggers (Delaware Revision)

Option:

Page 6H-34

1. For low-volume situations with short work zones on straight roadways where the flagger is visible to road users approaching from both directions, a single flagger, positioned to be visible to road users approaching from both directions, may be used (see Chapter 6E).

2. The ROAD WORK AHEAD and the END ROAD WORK signs may be omitted for short-duration operations.

3. A BE PREPARED TO STOP sign may be added to the sign series.

4. The buffer space should be extended so that the two-way traffic taper is placed before a horizontal (or crest vertical) curve to provide adequate sight distance for the flagger and a queue of stopped vehicles.

5. At night, flagger stations shall be illuminated, except in emergencies. Guidance:

6. When used, the BE PREPARED TO STOP sign should be located between the Flagger symbol (or FLAGGER AHEAD) sign and the ONE LANE ROAD sign.

7. Where drivers emerging from an intersecting roadway will not encounter an advance warning sign prior to the work zone, additional signs should be placed on the intersecting road. 8. When a grade crossing exists within or upstream of the transition area and it is anticipated that queues

resulting from the lane closure might extend through the grade crossing, the TTC zone should be extended so that the transition area precedes the grade crossing (see Figure 6H-46). 9. When a grade crossing equipped with active warning devices exists within the activity area, provisions should be made for keeping flaggers informed as to the activation status of these warning devices (see Figure

10. When a grade crossing exists within the activity area, drivers operating on the left-hand side of the normal center line should be provided with comparable warning devices as for drivers operating on the right-hand side of the normal center line (see Figure 6H-46).

11. Early coordination with the railroad company or light rail transit agency should occur before work starts (see Figure 6H-46).

12. A flagger or a uniformed law enforcement officer may be used at the upstream side of the grade crossing to

minimize the probability that vehicles are stopped within 50 feet of the grade crossing, measured from both sides of the outside rails (see Figure 6H-46). Standard:

13. For long-term, intermediate-term, and short-term operations, a truck-mounted attenuator shall be used on roadways with a posted speed limit or 85th-percentile speed greater than 40 mph.

14. For short duration operations along roadways with a posted speed limit or 85th-percentile speed greater than 40 mph, a truck-mounted attenuator may be omitted if a vehicle with activated high-intensity rotating, flashing, oscillating, or strobe lights is used.

15. Truck-mounted attenuators may be used for all operations along roadways with a posted speed limit or 85thpercentile speed less than or equal to 40 mph.

DE MUTCD

Figure 6H-10. Lane Closure on a Two-Lane Road Using Flaggers (TA-10) (Delaware Revision) Shadow vehicle Shadow vehicle -50 to 100 ft Truck-mounted attenuator (see Notes 13, 14, & 15) 50 to 100 ft (optional) Note: See Tables 6H-2 and 6H-3 for the meaning of the symbols and/or letter codes used in this figure. ROAD WORK **Typical Application 10**

Revision 1, December 2012

/Pennoni

Architects

Surveyors

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EXPENSES ARISING OUT OF OR RESULTING THEREFROM CNEW 1207 BLOCK MAP NO. 9 OF 12

DRAWING NO. 1"=30' KMS/TJA 12/14/2012

- 1. ALL WORK SHALL BE PERFORMED IN A MANNER THAT WILL REASONABLY PROVIDE THE LEAST PRACTICABLE OBSTRUCTION TO ROAD USERS, INCLUDING VEHICULAR TRAFFIC, BICYCLE TRAFFIC AND PEDESTRIAN TRAFFIC.
- 2. ALL TEMPORARY TRAFFIC CONTROL AND TEMPORARY TRAFFIC CONTROL DEVICES SHALL BE IN ACCORDANCE WITH: THE CONTRACT DOCUMENTS, THE LATEST EDITION OF THE MANUAL TITLED STATE OF DELAWARE MANUAL ON UNIFORM TRAFFIC CONTROL DEVICES (MUTCD) (HEREINAFTER REFERRED TO AS THE DELAWARE MUTCD), CURRENT STATE OF DELAWARE DEPARTMENT OF TRANSPORTATION STANDARD SPECIFICATIONS FOR ROAD AND BRIDGE CONSTRUCTION, AND SUPPLEMENTAL SPECIFICATIONS, INCLUDING ALL REVISIONS AS OF THE DATE OF THE ENTRANCE PERMIT APPROVAL.
- 3. THE DEPARTMENT RESERVES THE RIGHT TO STOP THE CONTRACTORS OPERATIONS. IF. IN THE OPINION OF THE DEPARTMENTS REPRESENTATIVE, THE CONTRACTORS OPERATIONS ARE NOT IN COMPLIANCE WITH THE DELAWARE MUTCD. THE SPECIFICATIONS OR THE PLANS OR IF THE CONTRACTORS OPERATIONS ARE DEEMED UNSAFE.
- 4. IF THE CONTRACTOR DESIRES TO DEVIATE FROM THE TEMPORARY TRAFFIC CONTROL PLAN (TTCP) PROVIDED IN THE PLAN SET OR DESIRES CHANGES TO THE PHASING OR SCOPE OF THE TTCP, THE CONTRACTOR SHALL SUBMIT A NEW TTCP TO THE DISTRICT SAFETY OFFICER FOR APPROVAL PRIOR TO THE START OF WORK AT EACH AND EVERY LOCATION. THE TTCP SHALL BE PREPARED, SIGNED AND SEALED BY A PROFESSIONAL ENGINEER REGISTERED IN THE STATE OF DELAWARE AND SHALL BE PREPARED IN ACCORDANCE WITH ALL APPLICABLE DELDOT STANDARDS. THE TTCP SHALL BE SUBMITTED 14 CALENDAR DAYS IN ADVANCE OF STARTING WORK.
- 5. ALL ROADWAY CLOSURES OR LANE CLOSURES BEYOND THOSE SPECIFIED AND APPROVED IN THE PLANS SHALL BE APPROVED BY THE DISTRICT SAFETY OFFICER A MINIMUM OF TWO WEEKS IN ADVANCE OF THE PROPOSED RESTRICTION.
- 6. TEMPORARY TRAFFIC CONTROL DEVICES SHALL BE MAINTAINED IN GOOD CONDITION IN ACCORDANCE WITH THE BROCHURE ENTITLED QUALITY GUIDELINES FOR TEMPORARY TRAFFIC CONTROL DEVICES, PUBLISHED BY THE AMERICAN TRAFFIC SAFETY SERVICES ASSOCIATION (ATSSA). ANY TEMPORARY TRAFFIC CONTROL DEVICES THAT DO NOT MEET THE QUALITY GUIDELINES SHALL BE REMOVED AND REPLACED WITH ACCEPTABLE DEVICES. FAILURE TO COMPLY WILL RESULT IN WORK STOPPAGE.
- 7. TEMPORARY TRAFFIC CONTROL DEVICES USED ON ALL ROADWAYS OPEN TO THE PUBLIC IN DELAWARE SHALL CONFORM TO THE DELAWARE MUTCD AND SHALL BE IN NEW OR REFURBISHED CONDITION, ALL DEVICES SHALL BE CRASHWORTHY IN ACCORDANCE WITH THE NATIONAL COOPERATIVE HIGHWAY RESEARCH PROGRAM (NCHRP) REPORT 350 AND/OR IN ACCORDANCE WITH THE LATEST EDITION OF THE MANUAL FOR ASSESSING SAFETY HARDWARE (MASH), PUBLISHED BY THE AMERICAN ASSOCIATION OF STATE HIGHWAY AND TRANSPORTATION OFFICIALS (AASHTO). THE CONTRACTOR SHALL SUBMIT CERTIFICATION FOR ALL TEMPORARY TRAFFIC CONTROL DEVICES USED SPECIFICALLY ON THIS PROJECT TO THE DISTRICT SAFETY OFFICER AT OR PRIOR TO THE PRE-CONSTRUCTION MEETING. THE CONTRACTOR SHALL NOT BEGIN WORK OR PLACE ANY TEMPORARY TRAFFIC CONTROL DEVICES UNTIL THE CERTIFICATION OF DEVICES HAS BEEN APPROVED BY THE DISTRICT SAFETY OFFICER.
- 8. ANY DEFICIENCIES RELATED TO TEMPORARY TRAFFIC CONTROL THAT ARE REPORTED TO THE CONTRACTOR IN WRITING SHALL BE CORRECTED WITHIN 24 HOURS OR AS DIRECTED BY THE DISTRICT SAFETY OFFICER. CORRECTIVE ACTIONS ON SEVERE DEFICIENCIES SHALL BE TAKEN IMMEDIATELY, FAILURE TO COMPLY WILL RESULT IN THE SUSPENSION OF WORK UNTIL DEVICES ARE BROUGHT BACK INTO COMPLIANCE.
- 9. ACCESS TO ALL BUSINESSES AND RESIDENCES WITHIN THE PROJECT LIMITS SHALL BE MAINTAINED THROUGHOUT THE DURATION OF THIS CONTRACT, ANY TEMPORARY CLOSURE OF A DRIVEWAY OR ENTRANCE FOR TIE-IN PURPOSES SHALL BE COORDINATED WITH THE ENGINEER AND THE PROPERTY OWNER IN ADVANCE OF THE CLOSURE.
- 10. ACCESS TO ALL TRANSIT STOPS LOCATED WITHIN THE PROJECT LIMITS SHALL BE MAINTAINED UNLESS OTHERWISE DIRECTED BY THE PLANS OR THE ENGINEER. MAINTAINING ACCESS TO THE TRANSIT STOP SHALL INCLUDE MAINTAINING AN AREA OF THE TRANSIT VEHICLE TO STOP TO PICK-UP AND DISCHARGE PASSENGERS AND ALSO AN ACCESSIBLE PATH FOR PEDESTRIANS TO SAFELY ACCESS THE TRANSIT STOP.
- 11. THE CONTRACTOR SHALL PROVIDE ALL PROPERTY OWNERS AND RESIDENTS WHO LIVE ADJACENT TO THE WORK ZONE WITH WRITTEN NOTICE. 48 HOURS IN ADVANCE OF THE START OF CONSTRUCTION WORK. THIS NOTIFICATION SHALL INCLUDE THE SCOPE OF WORK. WORKING HOURS. ANTICIPATED START AND COMPLETION DATES; A SUMMARY OF CONSTRUCTION ACTIVITIES WHICH MAY INTERFERE WITH ACCESS TO THE PROPERTY INCLUDING A SCHEDULE AND ACCESS COORDINATION PLAN, CONTRACTORS NAME AND ADDRESS AND A DELDOT CONTACT PHONE NUMBER. FAILURE TO GIVE PROPER NOTICE WILL RESULT IN A SUSPENSION OF THE WORK REQUIRING NOTICE, UNTIL PROPER NOTICE IS PROVIDED. THE CONTRACTOR SHALL PROVIDE WRITTEN VERIFICATION TO THE ENGINEER THAT THE PROPERTY OWNERS AND RESIDENTS WERE NOTIFIED.
- 12. THE CONTRACTOR SHALL BE RESPONSIBLE FOR NOTIFYING THE LOCAL 911 CENTER, LOCAL SCHOOLS AND THE DELDOT PUBLIC INFORMATION CENTER OF ALL ROADS AND LANES TO BE CLOSED A MINIMUM OF SEVEN CALENDAR DAYS BEFORE THE CLOSURE.
- 13. THE CONTRACTOR SHALL NOTIFY THE LOCAL 911 CENTER IF ACCESS TO A FIRE HYDRANT IS TEMPORARILY RESTRICTED.
- 14. THE CONTRACTOR SHALL BE RESPONSIBLE FOR ENSURING THAT THE TRANSPORTATION MANAGEMENT CENTER IS NOTIFIED EACH AND EVERY DAY WHEN WORK IS BEING PERFORMED IN STATE RIGHT-OF-WAY. THE CONTRACTOR SHALL IDENTIFY THE TYPE OF WORK, ANY LANE(S) OR SHOULDERS CLOSED, THE LENGTH OF TIME FOR WORK, WHEN THE LANE RESTRICTIONS ARE IN PLACE AND WHEN LANE RESTRICTIONS ARE LIFTED, CONTACT PERSON/PHONE NUMBER AND STATE INSPECTOR. THE TRANSPORTATION MANAGEMENT CENTER CAN BE REACHED AT (302) 659-4600.
- 15. AT THE END OF EACH WORKDAY, THE CONTRACTOR SHALL CORRECT ALL VERTICAL DIFFERENCES IN ACCORDANCE WITH TABLE 6G-1 OF THE DELAWARE MUTCD.
- 16. AT THE END OF EACH DAYS OPERATION AND BEFORE TRAFFIC IS RETURNED TO UNRESTRICTED ROADWAY USE, TEMPORARY PAVEMENT MARKINGS SHALL BE APPLIED IN ACCORDANCE WITH THE DELAWARE MUTCD AND DELDOTS TEMPORARY PAVEMENT MARKINGS POLICY.
- 17. WHEN SIDE ROADS INTERSECT THE WORK ZONE, ADDITIONAL TRAFFIC CONTROL DEVICES SHALL BE ERECTED INCLUDING PERMANENT WARNING SIGNS.
- 18. ALL STORAGE OF EQUIPMENT AND MATERIAL SHALL COMPLY WITH SECTION 6G. 22 OF THE DELAWARE MUTCD.
- 19. ALL FLAGGERS SHALL COMPLY WITH CHAPTER 6E OF THE DELAWARE MUTCD.
- 20. THE CONTRACTOR SHALL BE RESPONSIBLE FOR COORDINATING HIS/HER WORK WITH OTHER CONTRACTORS IN THE AREA.
- 21. ALL PERSONS WORKING WITHIN THE STATE RIGHT-OF-WAY SHALL WEAR A MINIMUM OF AN ANSI CLASS II SAFETY VEST MEETING OR EXCEEDING THE ANSI 107-2004 REQUIREMENTS. AS SPECIFIED IN THE DELAWARE MUTCD.

GENERAL M.O.T. NOTES (CONTINUED):

- 22. ALL PAVEMENT MARKINGS THAT ARE NO LONGER IN USE AND CONFLICT WITH TEMPORARY PAVEMENT MARKINGS SHALL BE REMOVED AND COMPLETELY OBLITERATED BY A METHOD APPROVED BY THE ENGINEER. PAINTING OVER THE CONFLICTING PAVEMENT MARKINGS WILL NOT BE ACCEPTED AS A METHOD OF REMOVAL.
- 23. THE CONTRACTOR IS RESPONSIBLE FOR THE MAINTENANCE OF EXISTING PAVEMENT WITHIN THE PROJECT LIMITS FOR THE DURATION OF THE CONTRACT OR AS DIRECTED BY THE ENGINEER.
- 24. ALL ROADWAYS AND ENTRANCES NOT OPEN TO TRAFFIC SHALL BE CLOSED USING TYPE III BARRICADES AND SHALL BE INSTALLED PER THE DELAWARE MUTCD. IF THE ROADWAY OR ENTRANCE IS CLOSED FOR MORE THAN ONE MONTH, THE CONTRACTOR SHALL ERECT PERMANENT BARRICADES AS DIRECTED IN PART 3 OF THE DELAWARE MUTCD.
- 25. WITHIN THE MAINLINE WORK AREA, PERMANENT ADVANCE WARNING SIGNS WITH THE LEGENDS ROAD WORK 1500 FT, ROAD WORK 1000 FT AND ROAD WORK 500 FT SHALL BE INSTALLED IN ADVANCE OF THE WORK AREA IN BOTH DIRECTIONS. AN END ROAD WORK SIGN SHALL BE LOCATED 500 FEET DOWNSTREAM FROM THE WORK AREA. ON INTERSECTING ROADWAYS WITHIN THE PROJECT LIMITS, A ROAD WORK AHEAD SIGN SHALL BE PLACED AT A DISTANCE NOT LESS THAN 500 FEET IN ADVANCE OF THE WORK AREA AND AN END ROAD WORK SIGN SHALL BE LOCATED 500 FEET DOWNSTREAM OF THE WORK AREA. ALL PERMANENT ADVANCE WARNING SIGNS SHALL BE GROUND MOUNTED ON TWO NCHRP-350 OR MASH APPROVED BREAKAWAY POSTS AND SHALL BE MOUNTED IN COMPLIANCE WITH THE DELAWARE MUTCD. PERMANENT ADVANCE WARNING SIGNS SHALL BE MOUNTED AT A HEIGHT OF 7 FEET, MEASURED FROM THE ROADWAY TO THE BOTTOM OF THE SIGN. THE USE OF SKID MOUNTED SIGN SUPPORTS IS NOT ALLOWED UNLESS THE CONTRACTOR CAN DEMONSTRATE THAT A UTILITY CONFLICT EXISTS. WHICH SHALL BE VERIFIED BY THE ENGINEER; OR CONCRETE MEDIANS PREVENT THE INSTALLATION OF THE PERMANENT ADVANCE WARNING SIGNS IN THE APPROPRIATE LOCATION.
- 26. TYPICAL APPLICATIONS PER THE DELAWARE MUTCD SHALL BE INCORPORATED TO ACHIEVE REQUIRED TEMPORARY TRAFFIC CONTROL AND SAFETY REQUIREMENTS. THIS PROJECT IS SUBJECT TO THE FOLLOWING TYPICAL APPLICATIONS UNLESS DIRECTED OTHERWISE BY THE DELDOT DISTRICT SAFETY OFFICER: TYPICAL APPLICATION 3 AND 10.

SEQUENCE OF CONSTRUCTION:

PHASE 1:

- 1. INSTALL TEMPORARY SIGNING AND TRAFFIC CONTROL DEVICES FOR PHASE 1. IN ACCORDANCE WITH THE DE MUTCD. TA-3 WORK ON THE SHOULDER OF A TWO-LANE ROAD.
- 2. CONSTRUCT STABILIZED CONSTRUCTION ENTRANCE AND INSTALL TEMPORARY EROSION AND SEDIMENT CONTROLS AS SHOWN ON THE PLAN.
- 3. EXISTING DELDOT DRAINAGE THAT WILL BE IMPACTED BY THE PROPOSED IMPROVEMENTS SHOULD BE MODIFIED PRIOR TO OTHER PROPOSED ACTIVITIES, SO AS TO MAINTAIN A CLEAN WATER DIVERSION THROUGH THE PROJECT AREA.
- 4. REMOVE EXISTING CURB ALONG WEST SIDE OF PAPER MILL ROAD.
- 5. CONSTRUCT PROPOSED CURB AND SIDEWALK ALONG WEST SIDE OF PAPER MILL ROAD.

PHASE 2:

- 1. INSTALL TEMPORARY SIGNING AND TRAFFIC CONTROL DEVICES FOR PHASE 2 IN ACCORDANCE WITH THE DE MUTCD, UTILIZE FLAGGING OPERATION DURING WORK IN THE MEDIAN OF PAPER MILL ROAD. ALL FLAGGING OPERATIONS SHALL COMPLY WITH SECTION 6E OF THE DELAWARE MUTCD.
- 2. REMOVE AND PATCH AREA OF THE EXISTING MEDIAN ALONG PAPER MILL ROAD ON THE SOUTH SIDE OF THE INTERSECTION WITH OLD PAPER MILL ROAD.
- 3. REMOVE AND REPLACE CURB RAMPS ON THE EAST SIDE OF PAPER MILL ROAD AT THE INTERSECTION WITH OLD PAPER MILL ROAD.

PHASE 3:

- 1. INSTALL TEMPORARY SIGNING AND TRAFFIC CONTROL DEVICES FOR PHASE 3, IN ACCORDANCE WITH THE DE MUTCD, TA-10 LANE CLOSURE ON A TWO-LANE ROAD USING FLAGGERS.
- 2. MILL AND OVERLAY WITH TYPE C WMA AS SHOWN ON SHEET 2 "CONSTRUCTION PLAN".
- 3. INSTALL PROPOSED SIGNING AND STRIPING AS SHOWN ON SHEET 11 "SIGNING AND STRIPING PLAN".

PEDESTRIAN MOT NOTES:

- 1. DURING CONSTRUCTION THE CONTRACTOR SHALL COORDINATE UPCOMING PEDESTRIAN IMPACTS WITH DELDOT SAFETY AT LEAST TWO (2) WEEKS IN ADVANCE OF THE CONSTRUCTION ACTIVITY.
- 2. PEDESTRIANS SHALL BE MAINTAINED ALONG THE WEST SIDE OF PAPER MILL ROAD USING THE NEW SIDEWALK BEING CONSTRUCTED THROUGH THE SITE WHICH IS TO BE TIED INTO THE EXISTING SIDEWALK TO THE NORTH AND SOUTH OF THE SITE.
- 3. A CROSSWALK SHALL BE MAINTAINED FROM THE PROPOSED SITE ENTRANCE ON THE WEST SIDE OF PAPER MILL ROAD TO THE NORTH EAST CORNER OF PAPER MILL ROAD AND OLD PAPER MILL ROAD FOR THE DURATION OF CONSTRUCTION.
- 4. MAINTAIN PEDESTRIANS WITH TEMPORARY PEDESTRIAN PATHS OR WITH A FLAGGING ASSISTANCE OPERATION DURING WORK HOURS AS NEEDED. SIDEWALK AND CURB RAMPS SHALL BE RETURNED TO A PASSABLE CONDITION AT THE END OF EACH WORK NIGHT. IF TEMPORARY PEDESTRIAN PATHS ARE TO BE USED THE CONTRACTOR SHALL COORDINATE WITH DELDOT SAFETY AT LEAST (2) WEEKS IN ADVANCE FOR APPROVAL.
- 5. ACCEPTABLE MATERIALS FOR TEMPORARY PEDESTRIAN PATHS SHALL INCLUDE CONCRETE. HOT-MIX. COMPACTED MILLINGS OR PLYWOOD WALKWAY STRUCTURE. PLYWOOD WALKWAY STRUCTURES SHALL ALSO INCLUDE DETECTABLE EDGING AND RAILINGS IN ACCORDANCE WITH ADA GUIDELINES AND THE DELAWARE MUTCD. STONE OR GRADED AGGREGATE BASE COURSE SHALL NOT BE USED FOR TEMPORARY PEDESTRIAN PATHS.



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ARE INSTRUMENTS OF SERVICE IN RESPECT OF THE TO BE SUITABLE FOR THE REUSE BY OWNER OR OTHER EXTENSIONS OF THE PROJECT OR ON ANY OTHER OJECT. ANY REUSE WITHOUT WRITTEN VERIFICATION OR ADAPTATION BY PENNONI ASSOCIATES FOR THE SPECIFIC PURPOSE INTENDED WILL BE AT OWNERS COLE RISK AND WITHOUT LIABILITY OR LEGAL EX-POSURE TO PENNONI ASSOCIATES; AND OWNER SHALL NDEMNIFY AND HOLD HARMLESS PENNONI ASSO-CIATES FROM ALL CLAIMS, DAMAGES, LOSSES AND

EXPENSES ARISING OUT OF OR RESULTING THEREFROM **CNEW 1207** 10 OF 12

DRAWING NO. 1"=30" 12/14/2012 APPROVED

